

# MSU PAISLEY COURT HOUSING

101 PAISLEY COURT  
BOZEMAN, MT, 59715

ISSUE DATE: 03/29/2024

MSU PPA NUMBER: 21-0143  
A&E PROJECT NUMBER: 21-0143



MSU-CPDC  
MONTANA STATE UNIVERSITY  
BOZEMAN, MONTANA  
PHONE: 406.994.5413  
FAX: 406.994.5665

MSU PAISLEY COURT  
HOUSING

BID/PERMIT SET



DRAWN BY: Author  
REVIEWED BY: Checker

REV.	DESCRIPTION	DATE

PPA #: 21-0143

A/E #: 21-0143

A&E PROJ #: 23123.00

SHEET TITLE  
COVER SHEET


SHEET  
**GO.0**

DATE  
03/29/24

## ARCHITECTURAL ABBREVIATIONS

AB ANCHOR BOLT	GA GAUGE	R RADIUS
ABV ABOVE	GALV GALVANIZED	RA RETURN AIR
A/C AIR CONDITIONING	GB GYPSUM BOARD	RB RUBBER BASE
ACT ACOUSTICAL CEILING TILE	GC GENERAL CONTRACTOR	RD ROOF DRAIN
ADDL ADDITIONAL	GL GLASS, GLAZING	RECY RECYCLE(D)
ADJ ADJUSTABLE	GWB GYPSUM WALL BOARD	REF REFERENCE
AFF ABOVE FINISH FLOOR	GYP GYPSUM	REFRIG REFRIGERATOR OR REFRIGERATION
ALT ALTERNATE	HC HANDICAP	REINF REINFORCE
ALUM ALUMINUM	HDR HEADER	REQD REQUIRED
ARCH ARCHITECT(URAL)	HDW HARDWARE	RM ROOM
AWN AWNING	HM HOLLOW METAL	RO ROUGH OPENING
	HORIZ HORIZONTAL	ROW RIGHT OF WAY
B/ BOTTOM OF	HR HOUR	S SOUTH
BD BOARD	HT HEIGHT	SC SOLID CORE
BLDG BUILDING	HTD HEATED	SC SCH SCHEDULE
BLKG BLOCKING	HTD HEATING/VENTILATION & AIR CONDITIONING	SCH SCHEDULED
BM BEAM OR BENCHMARK	HVAC	SECT SECTION
BRG BEARING	ID INSIDE DIAMETER	SF SQUARE FEET
BTWN BETWEEN	INFO INFORMATION	SFRM SPRAY APPLIED FIRE RESISTIVE MATERIAL
BUR BUILT-UP ROOF	ISO ISOCYANURATE	SGL SINGLE
	INSUL INSULATE / INSULATION	SHT SHEET
CAB CABINET	INT INTERIOR	SHTG SHEATHING
CJ CONTROL JOINT	INV INVERT	SIM SIMILAR
CL CENTERLINE	IT JOINT	SPECS SPECIFICATIONS
CLG CEILING	J-BOX JUNCTION BOX	SOD SLAB ON DECK
CMU CONCRETE MASONRY UNIT	KIT KITCHEN	SOG SLAB ON GRADE
CO CLEAN OUT	L LONG / LENGTH	SOH SAME OPPOSITE HAND
COL COLUMN	LAM LAMINATE(D)	SS STAINLESS STEEL
CONC CONCRETE	LAV LAVATORY	ST STONE TILE
CONT CONTINUOUS	LF LINEAR FEET	STD STANDARD
CONST CONSTRUCTION	LT LIGHT	STL STEEL
CG CORNER GUARD	MA MASONRY	STRUCT STRUCTURAL
CPT CARPET	MATL MATERIAL	TEMP TEMPERED
CSMT CASEMENT	MAX MAXIMUM	THK THICK
CT CERAMIC TILE	MECH MECHANICAL	THRESH THRESHOLD
	MEZZ MEZZANINE	T.O. TOP OF
D DEEP	MFR MANUFACTURER	TOBM TOP OF BEAM
DF DRINKING FOUNTAIN	MH MANHOLE	T.O.BM. TOP OF BEAM
DH DOUBLE HUNG	MIN MINIMUM	T.O.P. TOP OF PLATE
DM(S) DIMENSIONS	MISC MISCELLANEOUS	T.O.S. TOP OF STEEL
DISP DISPENSER	MO MASONRY OPENING	T/ TOP OF
DN DOWN	MTL METAL	T&G TONGUE AND GROOVE
DR DOOR	N NORTH	TEL TELEPHONE
DS DOWNSPOUT	NIC NOT IN CONTRACT	THK THICK
DTL DETAIL	NOM NOMINAL	TRANS TRANSOM
DWG DRAWING	NTS NOT TO SCALE	TV TELEVISION
E EAST	OC ON CENTER	TYP TYPICAL
EA EACH	OD OUTSIDE DIAMETER OR OVERFLOW	UL UNDERWRITERS LABORATORY
EC EXISTING COLUMN	OPP OPPOSITE	UNO UNLESS NOTED OTHERWISE
EJ EXPANSION JOINT	OSB ORIENTED STRAND BOARD	VB VINYL BASE
ELEC ELECTRICAL	OVD OVERHEAD	VCT VINYL COMPOSITION TILE
EL ELEVATION	PL PLATE	VERT VERTICAL
ELEV ELEVATOR	PLAM PLASTIC LAMINATE	VEST VESTIBULE
EQ EQUAL	PLUMB PLUMBING	VIF VERIFY IN FIELD
EQUIP EQUIPMENT	PLYWD PLYWOOD	VP VENEER PLASTER
EWC ELECTRIC WATER COOLER	PNL PANEL	VR VAPOR RETARDER
EXH EXHAUST	PNT PAINT	VT VINYL TILE
EXIST EXISTING	POLY POLYESTER OR POLYOLEFIN	VWC VINYL WALL COVERING
EXP EXPANSION OR EXPOSED	PSF POUNDS PER SQUARE FOOT	W WIDE OR WEST
EXT EXTERIOR	PSI POUNDS PER SQUARE INCH	W/ WITH
	PT PRESSURE TREATED OR POINT	WC WATER CLOSET
FACP FIRE ALARM CONTROL PANEL	PVMT PAVEMENT	WD WOOD
FD FLOOR DRAIN	QT QUARRY TILE	WGW WINDOW
FE FIRE EXTINGUISHER	QTR QUARTER	WG WALL GUARD
FEC FIRE EXTINGUISHER CABINET	QTY QUANTITY	WH WATER HEATER
F.F. FINISH FLOOR		WIN WITHIN
FIN FINISH		W/O WITHOUT
FIXT FIXTURE		WP WATERPROOF
FLR FLOOR		WR WATER RESISTANT
FLR FLOOR		WT WEIGHT
FND FOUNDATION		WWF WELDED WIRE FABRIC
FP FIRE PROTECTION		# NUMBER OR POUND
FR FRAME		@ AT
FRMG FRAMING		
FT FEET/FOOT OR FIRE TREATED		
FTG FOOTING		
FTNG FOOTING		
FRP FIBERGLASS REINFORCED PANEL		
FRT FIRE RETARDANT TREATED		

## EXPLANATION OF SYMBOLS

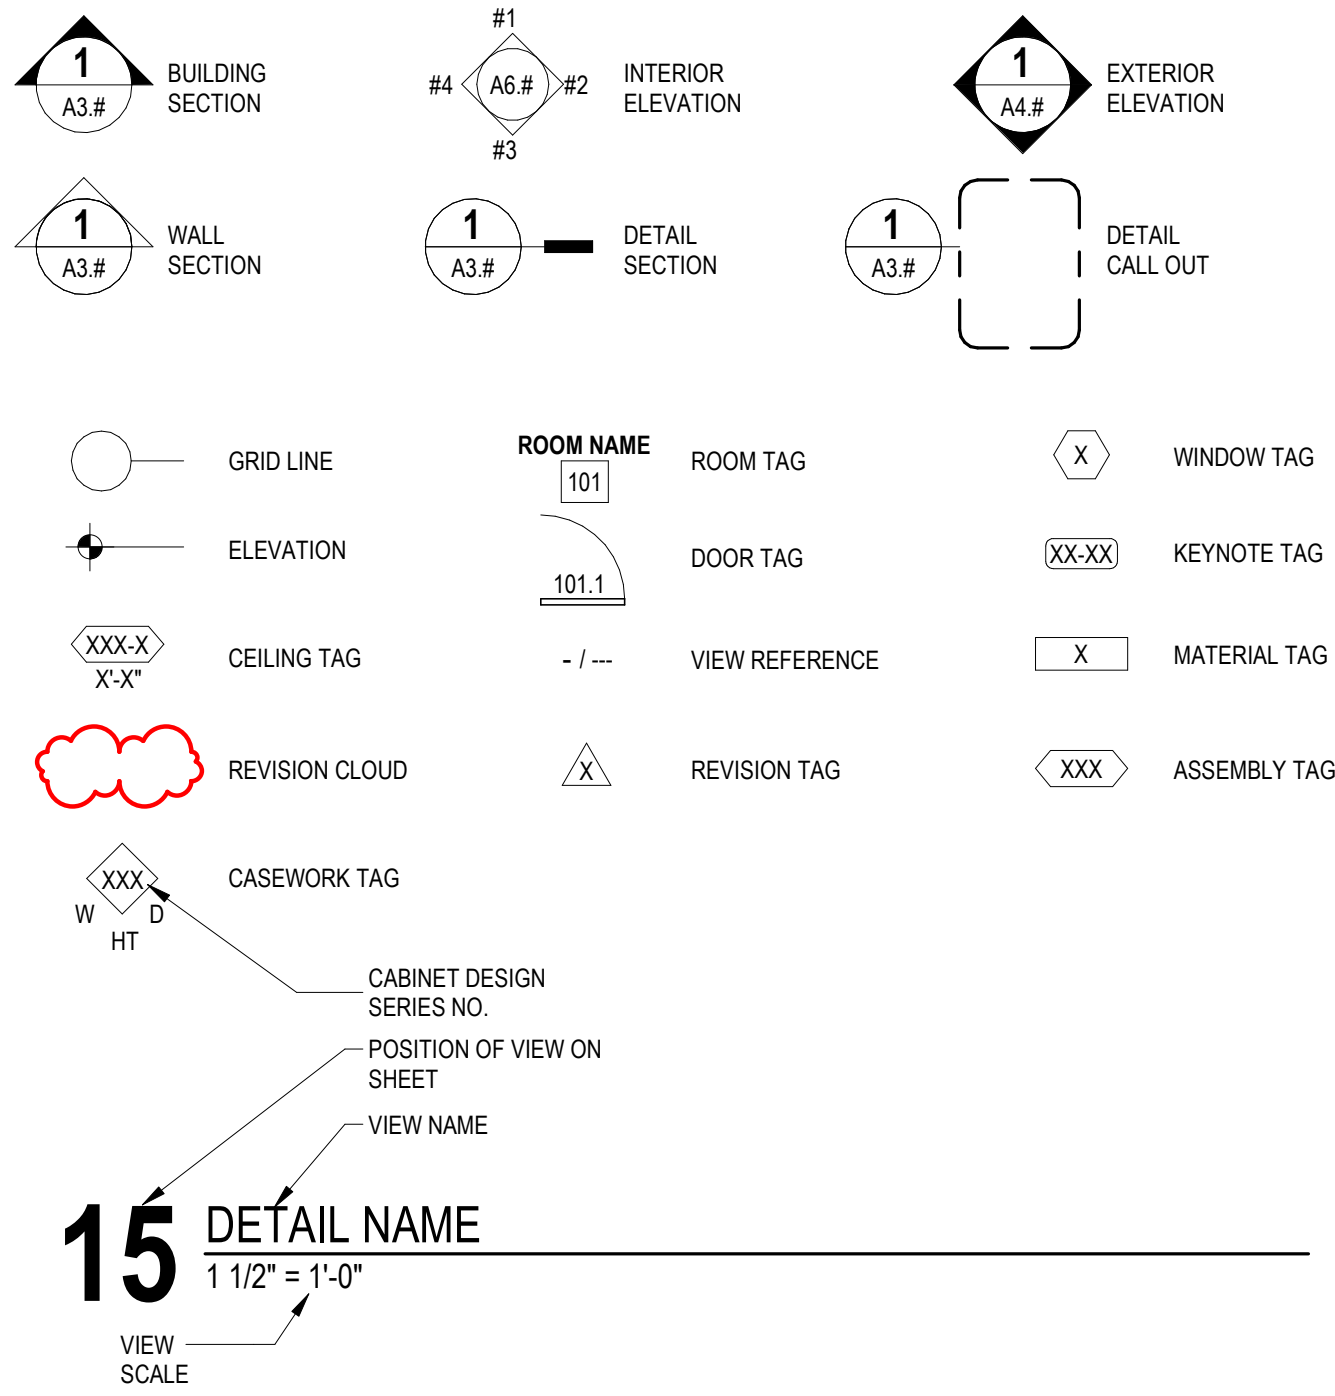

### TYPICAL SHEET VIEW NUMBERING LAYOUTS

1	2	3	4
5	6	7	8
9	10	11	12
13	14	15	16

ARCH D (24"x36")

### DISCLAIMER:

A&E DESIGN MAKES NO REPRESENTATION AS TO THE COMPLETENESS, APPROPRIATENESS, OR COORDINATION OF INFORMATION PROVIDED BY, AND IS NOT LIABLE FOR, THE WORK OF CONSULTANTS CONTRACTUALLY ENGAGED BY OTHERS.

## SUSTAINABILITY NOTES

- REPETITIVE AND/OR INTERMITTENT HIGH-LEVEL NOISE PERMITTED ONLY DURING DAYTIME. AT 50'-0" FROM THE PROJECT BOUNDARY DO NOT EXCEED 70 DB(A) FOR MORE THAN 12 MINUTES IN ANY HOUR.
- MAXIMUM AMBIENT NOISE LEVELS (DB) FOR NOISE AREA AT PROJECT BOUNDARY: DAYLIGHT HOURS 65 DB, NON-DAYLIGHT HOURS 45 DB.
- DEVELOP A WASTE MANAGEMENT PLAN ACCORDING TO ASTM E 1809. PLAN SHALL CONSIST OF WASTE IDENTIFICATION, WASTE REDUCTION WORK PLAN, AND COST/BENEFIT ANALYSIS. DISTINGUISH BETWEEN CONSTRUCTION WASTES. INDICATE QUANTITIES BY WEIGHT OR VOLUME, BUT USE SAME UNITS OF MEASURE THROUGHOUT WASTE MANAGEMENT PLAN.
- DEVELOP A WASTE REDUCTION WORK PLAN. IDENTIFY NON-HAZARDOUS DEMOLITION AND CONSTRUCTION WASTE GENERATED BY THE PROJECT AND WHETHER IT WILL BE SALVAGED, RECYCLED, OR DISPOSED OF IN LANDFILL. INCLUDE QUANTITY OF EACH TYPE OF WASTE, QUANTITY FOR EACH MEANS OF RECOVERY, AND HANDLING AND TRANSPORTATION PROCEDURES.
- RECYCLED MATERIALS: DIVERT. AT A MINIMUM, 50% OF RESULTING WASTE FROM A LANDFILL THROUGH SALVAGE AND RECYCLING. SEPARATE RECYCLABLE WASTE FROM OTHER WASTE MATERIALS, TRASH, AND DEBRIS.
- DEVELOP A CONSTRUCTION IAQ MANAGEMENT PLAN. AT A MINIMUM, SCHEDULE OF INSTALLATION OF INTERIOR FINISHES, IDENTIFY SOURCES OF ODOR AND DUST. NOTE CONSTRUCTION VENTILATION PROVIDED INCLUDING USE OF PERMANENT HVAC SYSTEMS, TYPES OF FILTRATION AND SCHEDULE FOR REPLACEMENT OF FILTERS, CLEANING AND DUST CONTROL PROCEDURES, PRODUCTS REQUIRING MOISTURE PROTECTION, AND SCHEDULE FOR INSPECTION OF STORED MATERIALS.
- DEVELOP A TEMPORARY SEDIMENTATION CONTROL PLAN. INDICATE DEVICES, MEASURES, AND LOCATIONS FOR SEDIMENT CONTROL DEVICES. DESCRIBE CONSTRUCTION ACTIVITIES EFFECTING EROSION, DESCRIBE MONITORING AND MEASURES FOR SEDIMENT CONTROL, DESCRIBE MITIGATION AND RESPONSE TO FAILED EROSION CONTROL MEASURES.
- LOW EMITTING MATERIALS. PAINTS, COATINGS, ADHESIVES AND SEALANTS FOR FIELD APPLICATIONS INSIDE THE WEATHER PROOFING SYSTEM SHALL COMPLY WITH VOC CONTENT LIMITS OF AUTHORITIES HAVING JURISDICTIONS OR SCAQMD RULE 1168, WHICHEVER IS STRICTER.
- NO SMOKING. SMOKING, VAPING, AND SMOKELESS TOBACCO USE IS NOT PERMITTED WITHIN THE BUILDING, OR WITHIN 25'-0" OF ENTRANCES, OPERABLE WINDOWS, OR OUTDOOR AIR INTAKES.
- ALL COMPOSITE WOOD PRODUCTS SHALL BE MANUFACTURED WITHOUT ADDED UREA FORMALDEHYDE.

## ARCHITECTURAL DRAWINGS

SHEET NO.	SHEET NAME
G0.0	COVER SHEET
G0.1	GENERAL INFORMATION
D2.1	LEVEL 1 DEMOLITION PLAN
D2.2	ROOF DEMOLITION PLAN
A1.1	SITE PLAN
A2.1	LEVEL 1 FLOOR PLAN
A2.2	ROOF PLAN
A4.1	EXTERIOR ELEVATIONS
A4.2	EXTERIOR ELEVATIONS
A7.1	REFLECTED CEILING PLANS
A8.1	SCHEDULES
A9.2	DETAILS

NOTE: TENANTS WILL OCCUPY THE BUILDINGS. PLEASE SEE NOTICE OF OCCUPANCY LETTER IN THE BID DOCUMENTS.

## PROJECT TEAM

### OWNER

MONTANA STATE UNIVERSITY  
PO BOX 172760  
BOZEMAN, MT 59717

CONTACT: DONNY BEEBE  
PROJECT MANAGER  
DONALD.BEEBE@MONTANA.EDU

### ARCHITECT

A&E ARCHITECTS  
515 W. ASPEN ST. SUITE 200A  
BOZEMAN, MT 59715  
406.453.7310

### CONTRACTOR

TBD

## ALTERNATES

**BASE BID:** REMOVE EXISTING DRIP EDGE FLASHING AND PROVIDE NEW FLASHING TUCKED UNDER EXISTING ROOFING AND FACE-ATTACHED THROUGH FASCIA PANEL.

**ALTERNATE #1:** REMOVE 3'-0" OF SHINGLES ALONG ALL ROOF EDGES TO ALLOW FOR INSTALLATION OF NEW DRIP EDGE FLASHING AND NEW UNDERLAYMENT. UNDERLAYMENT TO LAP OVER EXISTING UNDERLAYMENT, CONFIRM EXISTING IN FIELD. PROVIDE NEW SHINGLES TO MATCH EXISTING.

## APPLICABLE CODES AND ORDINANCES

2021 INTERNATIONAL BUILDING CODE (IBC)  
2021 INTERNATIONAL ENERGY CONSERVATION CODE  
2021 INTERNATIONAL FIRE CODE (IFC)  
2021 INTERNATIONAL MECHANICAL CODE (IMC)  
2021 INTERNATIONAL FUEL GAS CODE (IFGC)  
2021 UNIFORM PLUMBING CODE  
2020 NATIONAL ELECTRICAL CODE  
2017 ACCESSIBLE AND USABLE BUILDINGS AND FACILITIES (ICC/ANSI 117.1)



MSU-CPDC  
MONTANA STATE UNIVERSITY  
BOZEMAN, MONTANA  
PHONE: 406.994.5413  
FAX: 406.994.5665

MSU PAISLEY COURT  
HOUSING

BID/PERMIT SET



DRAWN BY: <b>Author</b>		
REVIEWED BY: <b>Checker</b>		
REV.	DESCRIPTION	DATE
1	Addendum #1	12/18/24

PPA #:	21-0143
--------	---------

A/E #	21-0143
-------	---------

A&E PROJ #:	23123.00
-------------	----------

SHEET TITLE  
GENERAL INFORMATION

SHEET  
**G0.1**

DATE  
**03/29/24**

**GENERAL NOTES**

- 101 BUILDING 'B/C' & 102 BUILDING 'B/C' ARE MIRRORED VERSIONS OF TYPICAL BUILDING.
- GUTTERS AND DOWNSPOUTS TO BE REMOVED AND REPLACED THROUGHOUT

**KEYNOTES**

- A** REMOVE EXISTING SIDING DOWN TO EXTERIOR SHEATHING, INCLUDING ALL TRIM PIECES, SOFFIT BOARDS, FLASHING, AND ANY EXISTING BUILDING WRAP.
- B** PROTECT EXISTING BRICK TO REMAIN.
- C** REMOVE EXISTING WINDOWS, INCLUDING FLASHING AS REQUIRED FOR INSTALLATION OF NEW WINDOWS.


**DEMOLITION LEGEND**

- HATCH INDICATES AREA NOT IN SCOPE OF WORK
- INDICATES BUILT ITEM TO BE REMOVED
- INDICATES LIGHT FIXTURE TO BE REMOVED


**DEMOLITION NOTES**

- IT IS THE CONTRACTOR'S RESPONSIBILITY TO FAMILIARIZE HIMSELF/HERSELF WITH THE SCOPE OF WORK.
- THE DEMOLITION NOTES PROVIDE A GENERAL DESCRIPTION OF THE ITEMS AND AREAS REQUIRING REMOVAL. THE CONTRACTOR SHALL FIELD VERIFY ACTUAL QUANTITIES AND LOCATIONS OF ALL INDICATED ITEMS AS NECESSARY TO COMPLETE THE SCOPE OF WORK IN ACCORDANCE WITH THE CONTRACT DOCUMENTS.
- COORDINATE WITH OWNER FOR ANY EQUIPMENT TO BE SALVAGED. UNLESS SPECIFICALLY SCHEDULED FOR REUSE, DEMOLISHED MATERIALS SHALL BECOME THE POSSESSION OF THE CONTRACTOR AND SHALL BE IMMEDIATELY REMOVED FROM THE SITE.
- REMOVE MATERIALS FROM SITE AND DISPOSE OF IN A LEGAL MANNER AT NO ADDITIONAL EXPENSE TO OWNER.
- DEBRIS FROM THE DEMOLITION SHALL NOT BE ALLOWED TO ACCUMULATE WITHIN THE BUILDING OR ON THE SITE.
- REMOVE FROM SITE ANY CONTAMINATED, VERMIN INFESTED, OR DANGEROUS MATERIALS ENCOUNTERED AND DISPOSE OF BY SAFE MEANS SO AS NOT TO ENDANGER HEALTH OF WORKERS AND PUBLIC.
- BURNING OF MATERIALS ON SITE IS NOT PERMITTED.
- CLEAN-UP MUST MEET GOVERNING DUST CONTROL CODES.
- NOTIFY AFFECTED UTILITY COMPANIES BEFORE STARTING WORK AND COMPLY WITH THEIR REQUIREMENTS.
- PREVENT MOVEMENT OR SETTLEMENT OF ADJACENT STRUCTURES. PROVIDE BRACING AND SHORING.
- CARRY OUT DEMOLITION WORK TO CAUSE AS LITTLE INCONVENIENCE TO ANY ADJACENT OCCUPIED BUILDING OR SITE AS POSSIBLE AND WITH MINIMUM INTERFERENCE TO PUBLIC OR PRIVATE ACCESSES. MAINTAIN PROTECTED EGRESS AND ACCESS AT ALL TIMES.
- CONTRACTOR SHALL PROVIDE TEMPORARY DUST AND CONSTRUCTION SEPARATION WALLS AS REQUIRED TO SHIELD THE PUBLIC FROM NOISE, DUST, WEATHER, AND OTHER HAZARDS THAT MAY BE EXPOSED AS A RESULT OF THE DEMOLITION WORK.
- CONTRACTOR SHALL TAKE ALL NECESSARY PRECAUTIONS TO INSURE EXISTING STRUCTURAL ELEMENTS REMAIN UNDAMAGED THROUGHOUT CONSTRUCTION UNLESS SPECIFICALLY NOTED ON DEMOLITION PLAN. IT IS THE SOLE RESPONSIBILITY OF THE CONTRACTOR TO IDENTIFY AND PROVIDE ANY SHORING, BRACING, OR TEMPORARY STRUCTURE, AND TO COORDINATE WITH STRUCTURAL ENGINEER AS REQUIRED.
- ALL PUBLIC UTILITIES TO REMAIN IN OPERATION THROUGHOUT CONSTRUCTION. CONTRACTOR TO COORDINATE ANY TEMPORARY SERVICES REQUIRED TO MAINTAIN BUSINESS OPERATIONS.
- FIRE SAFETY MUST BE MAINTAINED FOR ALL PERSONNEL WORKING ON THE FLOOR. ALL FIRE STAIRS, ALARMS, SPEAKERS, ETC. MUST REMAIN ACCESSIBLE AND OPERABLE AT ALL TIMES. CONTRACTOR SHALL MAKE NECESSARY PROVISIONS TO PROTECT THIS EQUIPMENT. IMMEDIATELY NOTIFY BUILDING SECURITY AND BUILDING MANAGER OF DAMAGED OR DISABLED SYSTEMS AND REPAIR OR REPLACE DAMAGED SYSTEMS IMMEDIATELY.
- IF ANY QUESTIONS ARISE AS TO THE REMOVAL OF ANY MATERIAL, CLARIFY THE POINT IN QUESTION WITH THE OWNER BEFORE PROCEEDING. IMMEDIATELY STOP WORK IF HAZARDOUS MATERIALS ARE FOUND AND CONTACT THE OWNER'S REPRESENTATIVE.
- REMOVAL OF ANY EQUIPMENT, CABLING SWITCHES, AND CONDUIT PERTAINING TO DATA/COMMUNICATIONS AND TELEPHONE SHALL BE VERIFIED WITH TELEPHONE COMPANIES. SERVICE OWNER OR TENANT DATA/COMMUNICATIONS REPRESENTATIVE AS REQUIRED TO PREVENT NEW CONSTRUCTION DELAYS.
- PROVIDE FOR FIRE PROOFING REPAIR AS REQUIRED AT STRUCTURAL STEEL. TO THE ORIGINAL RATING WHERE CONSTRUCTION TRADES REMOVE EXISTING FIRE PROOFING. REPAIR ANY DAMAGE OR PENETRATIONS IN RATED ASSEMBLIES TO CONFORM TO THEIR ORIGINAL LISTING REQUIREMENTS AND TO MAINTAIN FIRE PROTECTION AND SEPARATION AS ORIGINALLY DESIGNED.
- AT COMPLETION OF DEMOLITION WORK, THE CONSTRUCTION AREA(S) SHALL BE LEFT IN 'BROOM CLEAN' CONDITION. ALL DEBRIS AND MISCELLANEOUS MATERIAL SHALL BE REMOVED.
- CONTRACTOR SHALL BE RESPONSIBLE FOR PATCHING AND/OR REPAIRING ANY DAMAGE CAUSED BY HIM OR HIS SUBCONTRACTORS. REFINISH TO MATCH EXISTING ADJACENT FINISH, OR AS NOTED HEREIN.
- FOR AREAS NOT IN DEMOLITION SCOPE OF WORK, PROTECT AS REQUIRED. ALL SURFACES, EQUIPMENT, FIXTURES AND HARDWARE DURING DEMOLITION AND/OR CONSTRUCTION.
- PRIOR TO DEMOLITION, INVESTIGATE WALLS FOR CONCEALED PIPING AND INFORM OWNER/ARCHITECT OF ANY CONDITION NOT DOCUMENTED IN CONTRACT DRAWINGS. DEMO DESIGNATED WALL BASES, WALL FRAMING, BATT INSULATION AND GYPSUM BOARD. DEMO CONDUITS AND RECEPTACLES. REFERENCE ELECTRICAL DEMO PLAN FOR ADDITIONAL INFORMATION.


BID/PERMIT SET

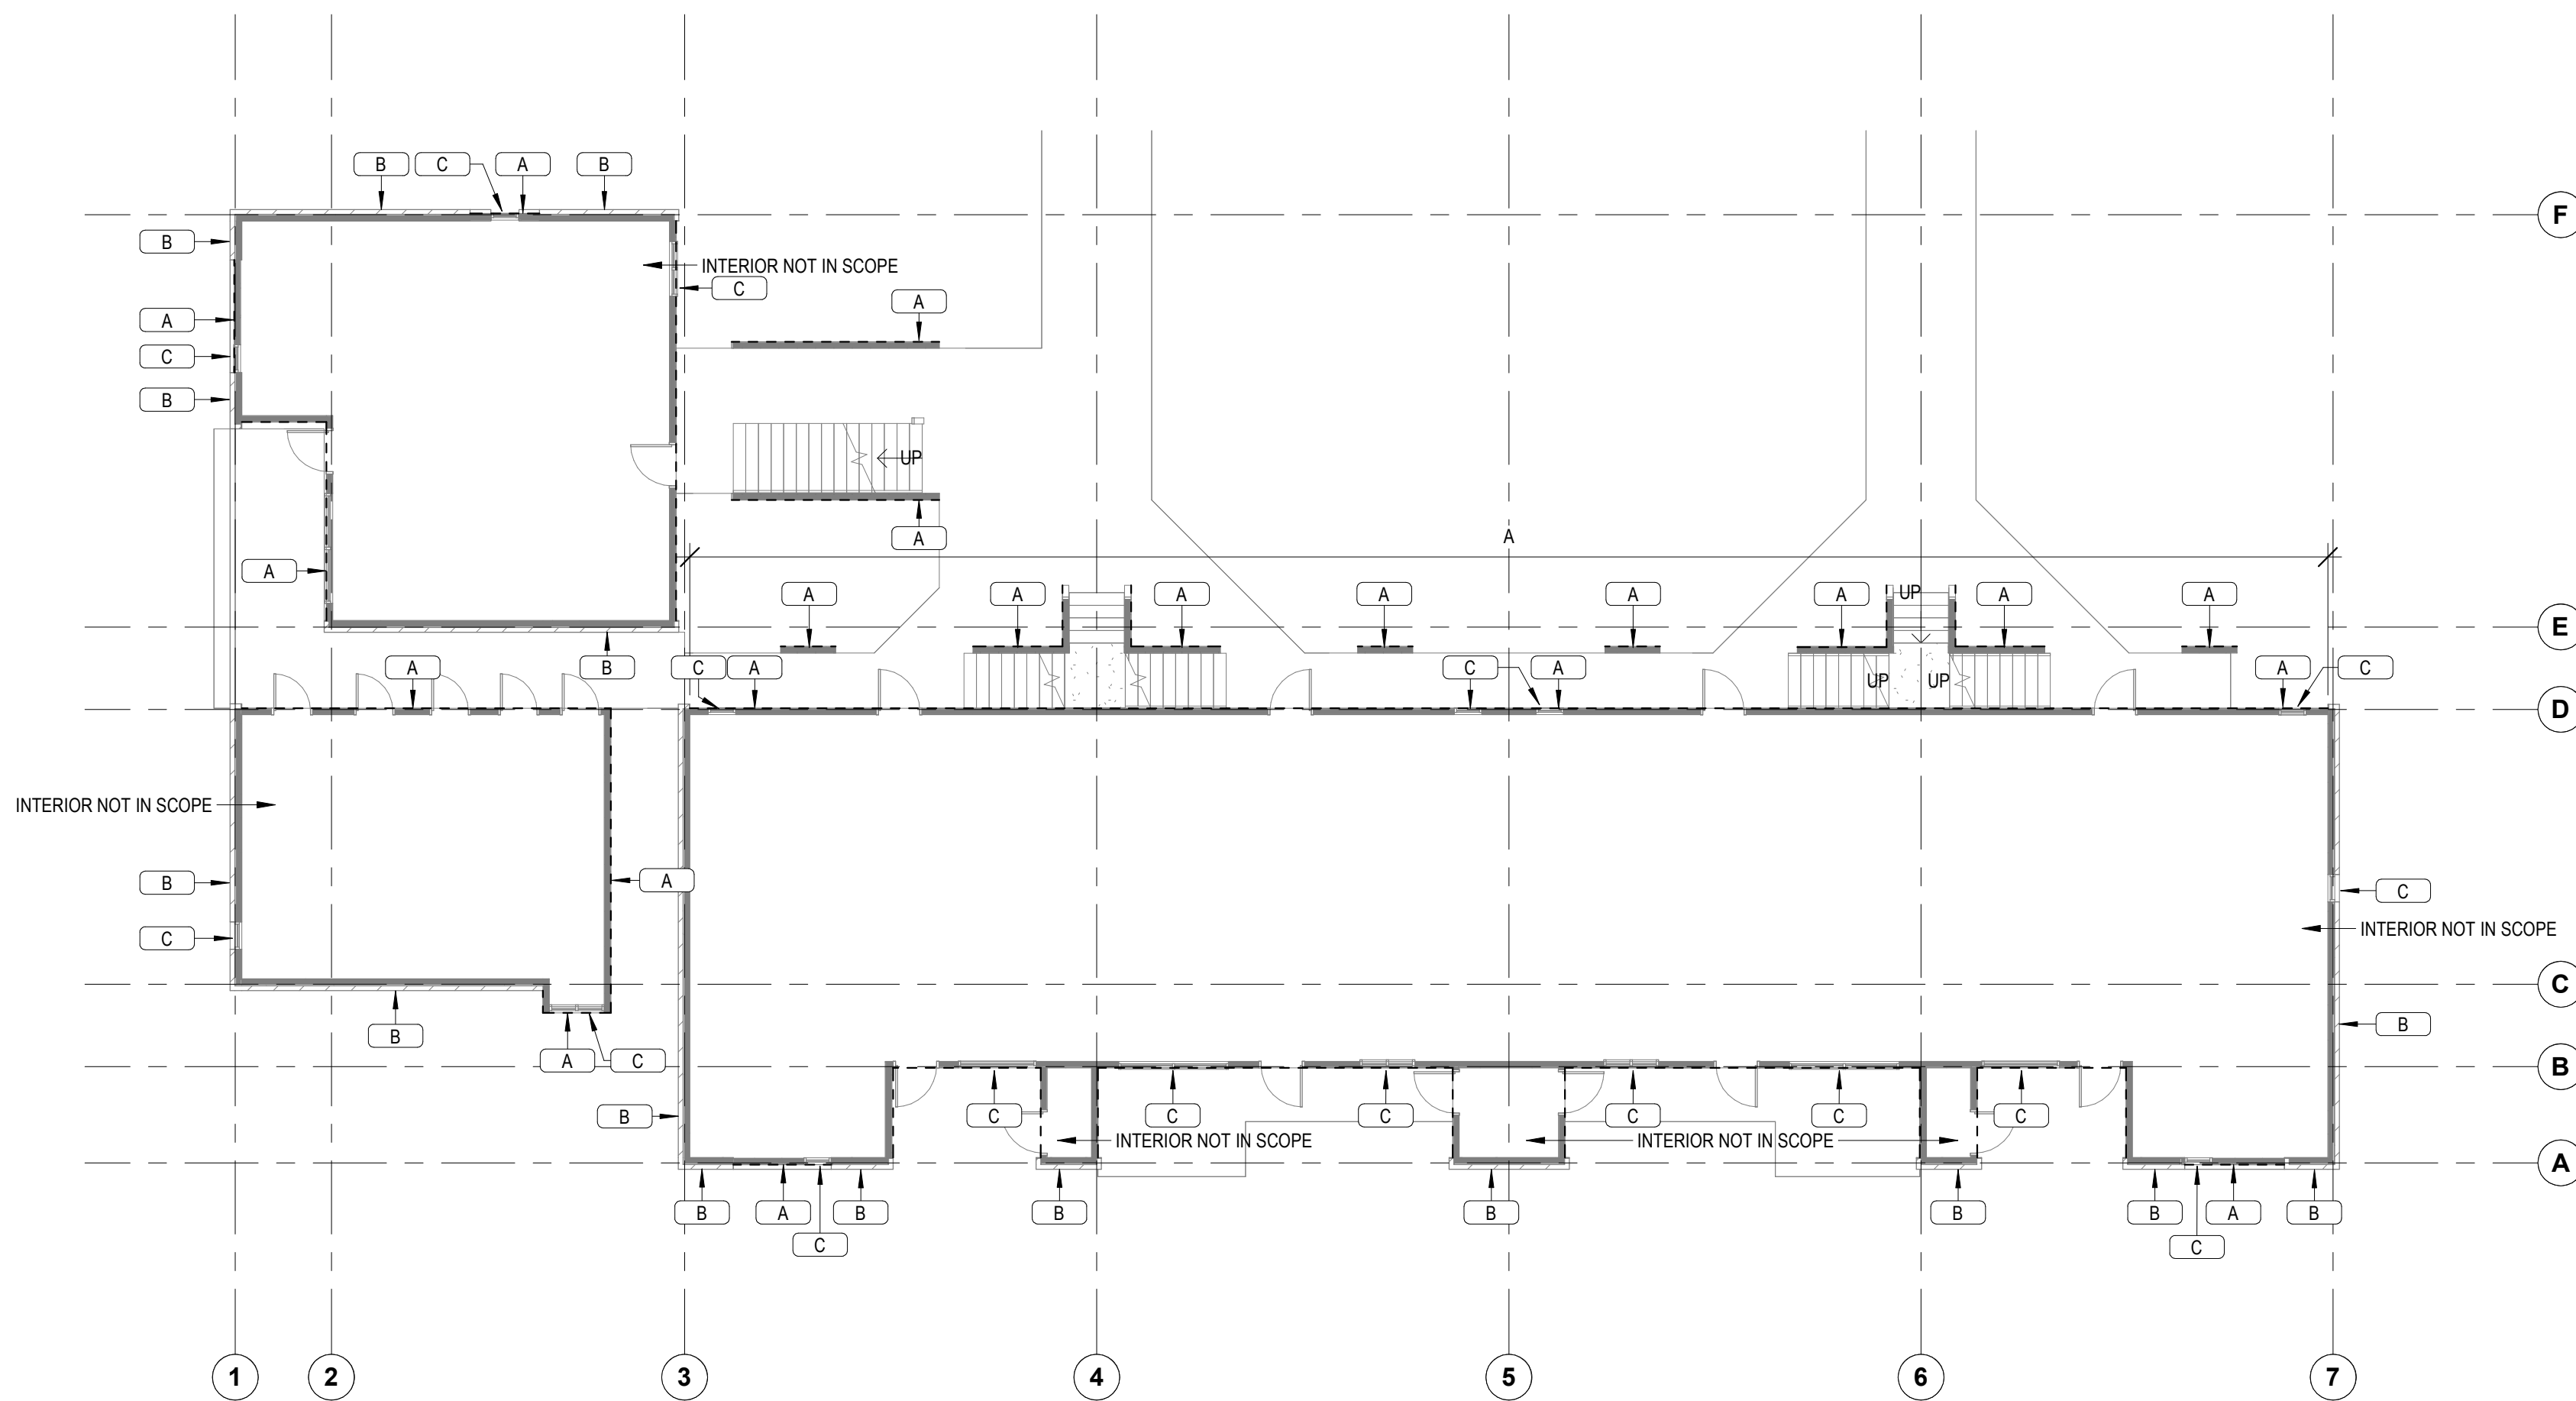

**5** LEVEL 1 DEMO  
3/32" = 1'-0"

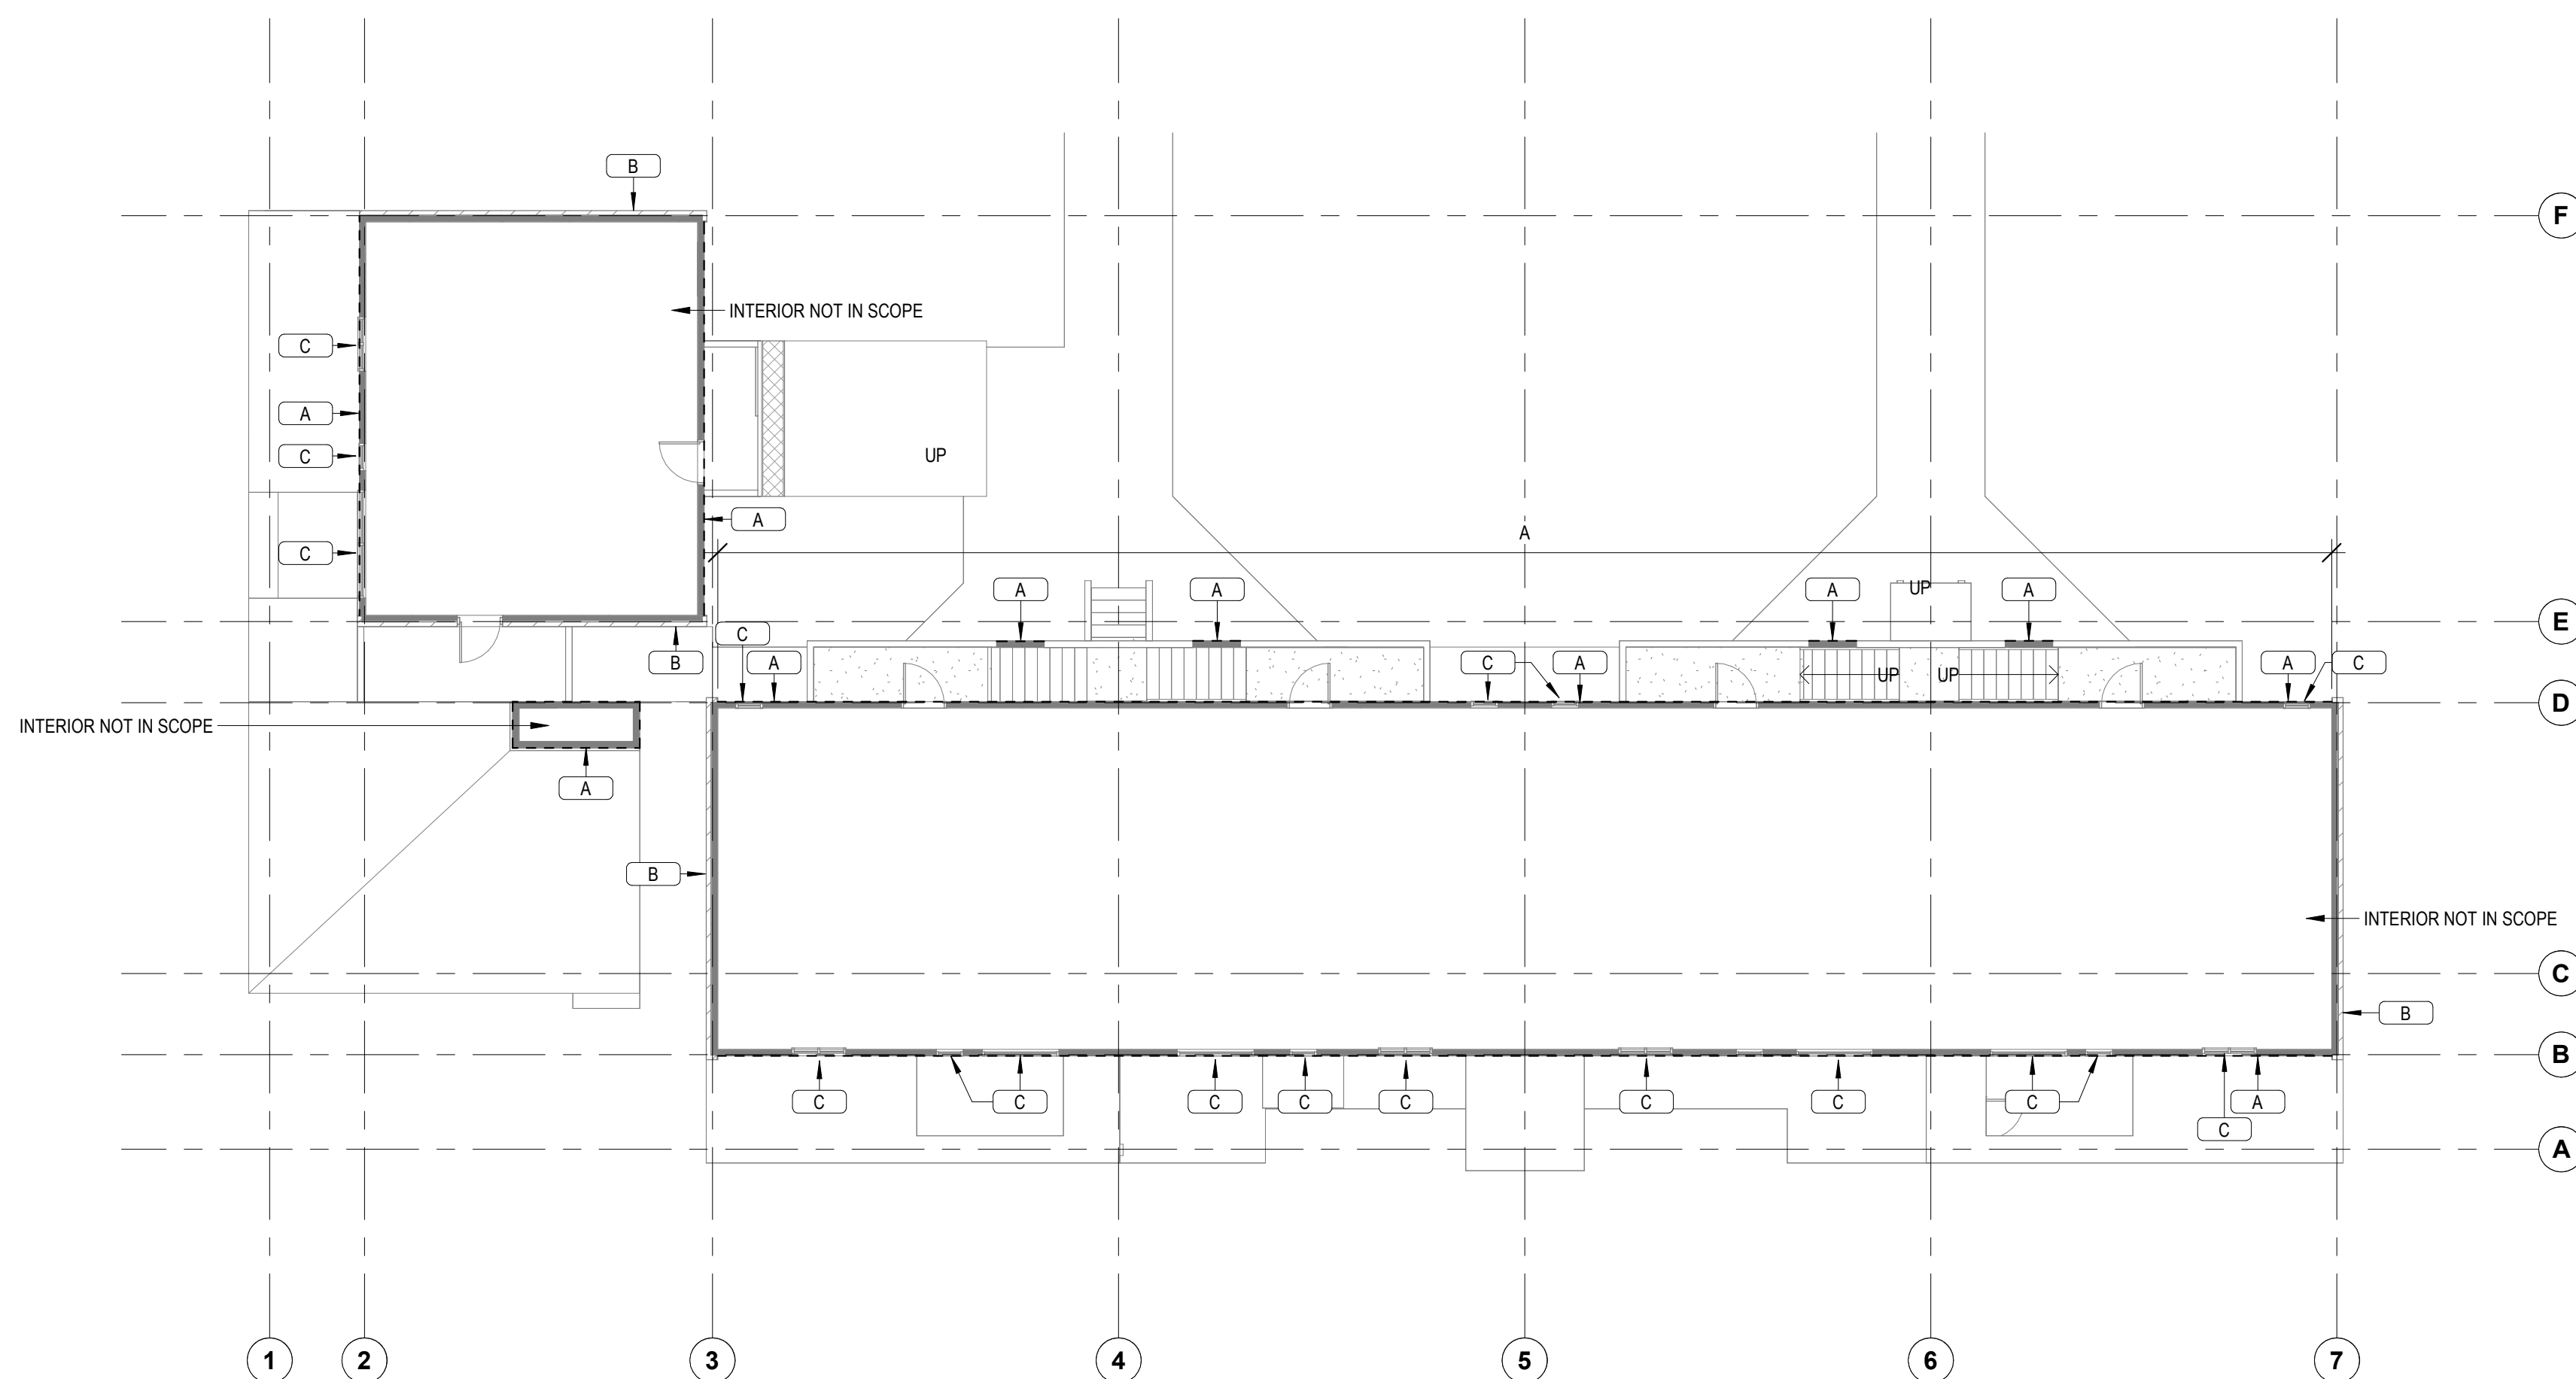

**13** LEVEL 2 DEMO  
3/32" = 1'-0"

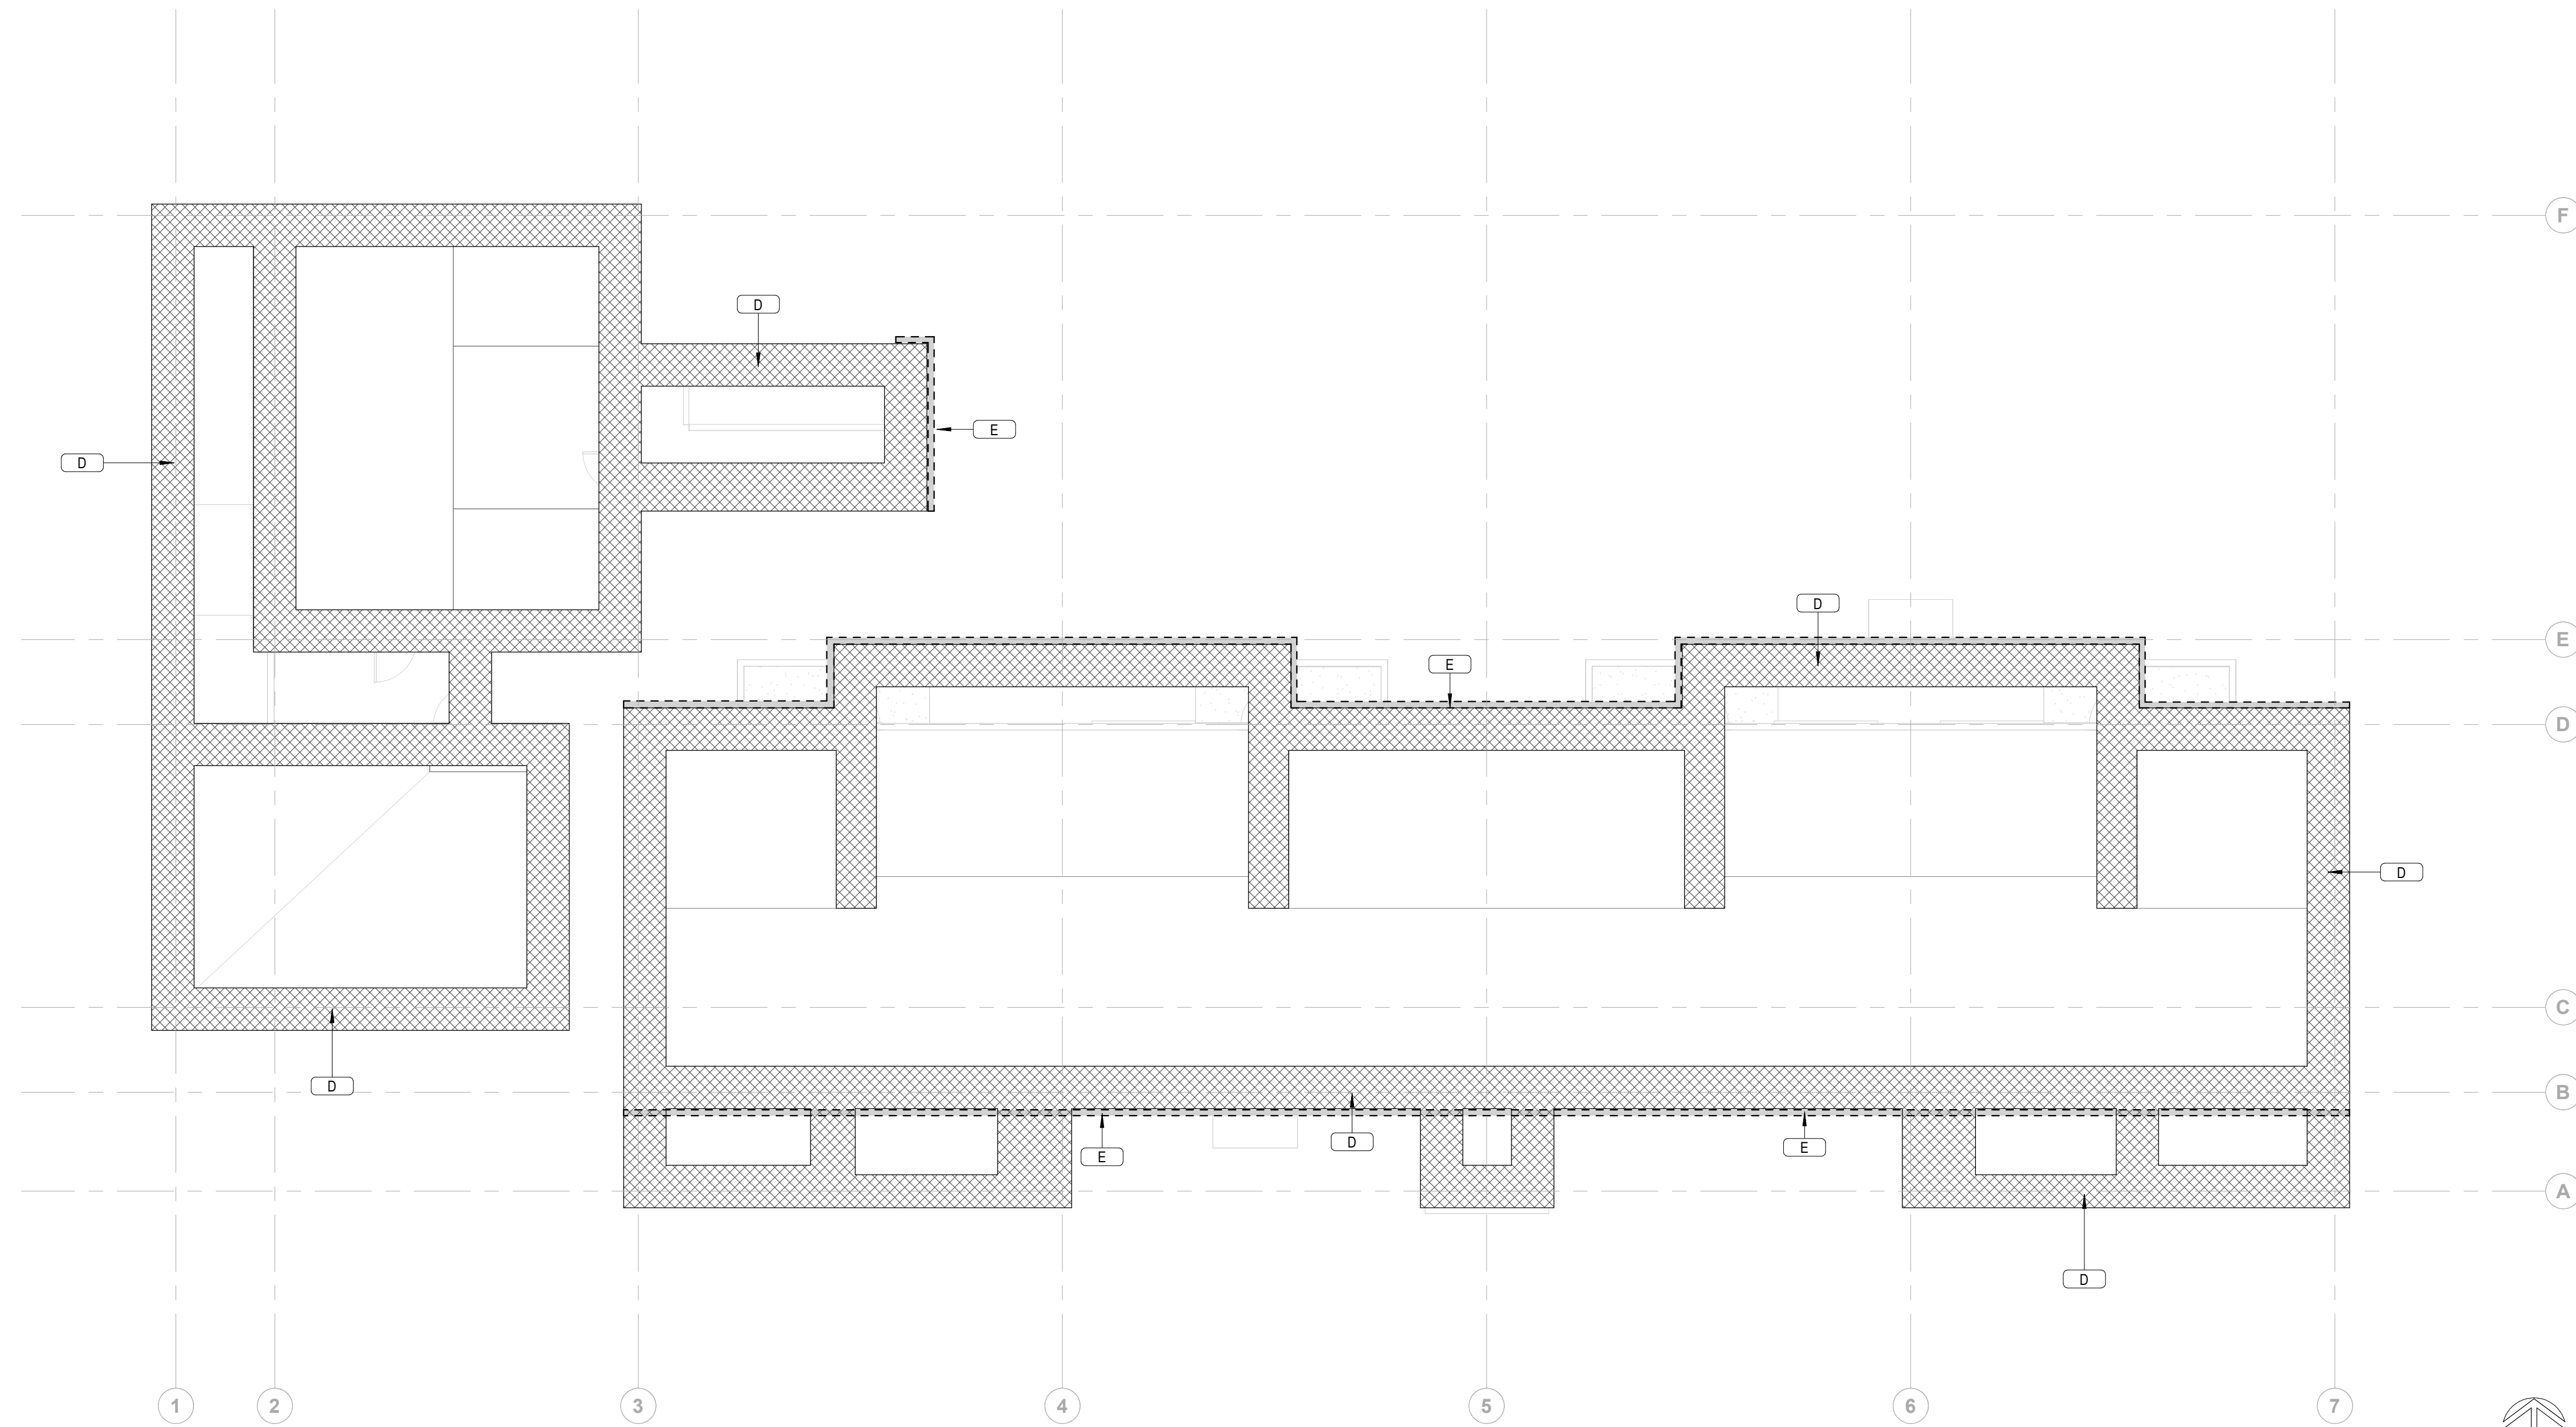

**1 ROOF DEMO**  
1/8" = 1'-0"

**GENERAL NOTES**

- 101 BUILDING 'B/C' & 102 BUILDING 'B/C' ARE MIRRORED VERSIONS OF TYPICAL BUILDING.
- GUTTERS AND DOWNSPOUTS TO BE REMOVED AND REPLACED THROUGHOUT

**KEYNOTES**



- D** ALTERNATE #1: REMOVE AND LEGALLY DISPOSE OF 3'-0" OF SHINGLES AT ALL ROOF EDGES FOR INSTALLATION OF NEW DRIP EDGE FLASHING.
- E** REMOVE AND LEGALLY DISPOSE OF ALL GUTTERS AND FASTENERS

**DEMOLITION LEGEND**

- HATCH INDICATES AREA NOT IN SCOPE OF WORK
- INDICATES BUILT ITEM TO BE REMOVED
- INDICATES LIGHT FIXTURE TO BE REMOVED

**DEMOLITION NOTES**

- IT IS THE CONTRACTOR'S RESPONSIBILITY TO FAMILIARIZE HIMSELF/HERSELF WITH THE SCOPE OF WORK.
- THE DEMOLITION NOTES PROVIDE A GENERAL DESCRIPTION OF THE ITEMS AND AREAS REQUIRING REMOVAL. THE CONTRACTOR SHALL FIELD VERIFY ACTUAL QUANTITIES AND LOCATIONS OF ALL INDICATED ITEMS AS NECESSARY TO COMPLETE THE SCOPE OF WORK IN ACCORDANCE WITH THE CONTRACT DOCUMENTS.
- COORDINATE WITH OWNER FOR ANY EQUIPMENT TO BE SALVAGED. UNLESS SPECIFICALLY SCHEDULED FOR REUSE, DEMOLISHED MATERIALS SHALL BECOME THE POSSESSION OF THE CONTRACTOR AND SHALL BE IMMEDIATELY REMOVED FROM THE SITE.
- REMOVE MATERIALS FROM SITE AND DISPOSE OF IN A LEGAL MANNER AT NO ADDITIONAL EXPENSE TO OWNER.
- DEBRIS FROM THE DEMOLITION SHALL NOT BE ALLOWED TO ACCUMULATE WITHIN THE BUILDING OR ON THE SITE.
- REMOVE FROM SITE ANY CONTAMINATED, VERMIN INFESTED, OR DANGEROUS MATERIALS ENCOUNTERED AND DISPOSE OF BY SAFE MEANS SO AS NOT TO ENDANGER HEALTH OF WORKERS AND PUBLIC.
- BURNING OF MATERIALS ON SITE IS NOT PERMITTED.
- CLEAN-UP: MUST MEET GOVERNING DUST CONTROL CODES.
- NOTIFY AFFECTED UTILITY COMPANIES BEFORE STARTING WORK AND COMPLY WITH THEIR REQUIREMENTS.
- PREVENT MOVEMENT OR SETTLEMENT OF ADJACENT STRUCTURES. PROVIDE BRACING AND SHORING.
- CARRY OUT DEMOLITION WORK TO CAUSE AS LITTLE INCONVENIENCE TO ANY ADJACENT OCCUPIED BUILDING OR SITE AS POSSIBLE AND WITH MINIMUM INTERFERENCE TO PUBLIC OR PRIVATE ACCESS. MAINTAIN PROTECTED EGRESS AND ACCESS AT ALL TIMES.
- CONTRACTOR SHALL PROVIDE TEMPORARY DUST AND CONSTRUCTION SEPARATION WALLS AS REQUIRED TO SHIELD THE PUBLIC FROM NOISE, DUST, WEATHER, AND OTHER HAZARDS THAT MAY BE EXPOSED AS A RESULT OF THE DEMOLITION WORK.
- CONTRACTOR SHALL TAKE ALL NECESSARY PRECAUTIONS TO INSURE EXISTING STRUCTURAL ELEMENTS REMAIN UNDAMAGED THROUGHOUT CONSTRUCTION, UNLESS SPECIFICALLY NOTED ON DEMOLITION PLAN. IT IS THE SOLE RESPONSIBILITY OF THE CONTRACTOR TO IDENTIFY AND PROVIDE ANY SHORING, BRACING, OR TEMPORARY STRUCTURE, AND TO COORDINATE WITH STRUCTURAL ENGINEER AS REQUIRED.
- ALL PUBLIC UTILITIES TO REMAIN IN OPERATION THROUGHOUT CONSTRUCTION. CONTRACTOR TO COORDINATE ANY TEMPORARY SERVICES REQUIRED TO MAINTAIN BUSINESS OPERATIONS.
- FIRE SAFETY MUST BE MAINTAINED FOR ALL PERSONNEL WORKING ON THE FLOOR. ALL FIRE STAIRS, ALARMS, SPEAKERS, ETC. MUST REMAIN ACCESSIBLE AND OPERABLE AT ALL TIMES. CONTRACTOR SHALL MAKE NECESSARY PROVISIONS TO PROTECT THIS EQUIPMENT. IMMEDIATELY NOTIFY BUILDING SECURITY AND BUILDING MANAGER OF DAMAGED OR DISABLED SYSTEMS AND REPAIR OR REPLACE DAMAGED SYSTEMS IMMEDIATELY.
- IF ANY QUESTIONS ARISE AS TO THE REMOVAL OF ANY MATERIAL, CLARIFY THE POINT IN QUESTION WITH THE OWNER BEFORE PROCEEDING. IMMEDIATELY STOP WORK IF HAZARDOUS MATERIALS ARE FOUND AND CONTACT THE OWNER'S REPRESENTATIVE.
- REMOVAL OF ANY EQUIPMENT, CABLING SWITCHES, AND CONDUIT PERTAINING TO DATA/COMMUNICATIONS AND TELEPHONE SHALL BE VERIFIED WITH TELEPHONE COMPANIES, SERVICE OWNER OR TENANT DATA/COMMUNICATIONS REPRESENTATIVE AS REQUIRED TO PREVENT NEW CONSTRUCTION DELAYS.
- PROVIDE FOR FIRE PROOFING REPAIR AS REQUIRED AT STRUCTURAL STEEL, TO THE ORIGINAL RATING WHERE CONSTRUCTION TRADES REMOVE EXISTING FIRE PROOFING. REPAIR ANY DAMAGE OR PENETRATIONS IN RATED ASSEMBLIES TO CONFORM TO THEIR ORIGINAL LISTING REQUIREMENTS AND TO MAINTAIN FIRE PROTECTION AND SEPARATION AS ORIGINALLY DESIGNED.
- AT COMPLETION OF DEMOLITION WORK, THE CONSTRUCTION AREA(S) SHALL BE LEFT IN "BROOM CLEAN" CONDITION. ALL DEBRIS AND MISCELLANEOUS MATERIAL SHALL BE REMOVED.
- CONTRACTOR SHALL BE RESPONSIBLE FOR PATCHING AND/OR REPAIRING ANY DAMAGE CAUSED BY HIM OR HIS SUBCONTRACTORS. FINISH TO MATCH EXISTING ADJACENT FINISH, OR AS NOTED HEREIN.
- FOR AREAS NOT IN DEMOLITION SCOPE OF WORK, PROTECT AS REQUIRED. ALL SURFACES, EQUIPMENT, FIXTURES AND HARDWARE DURING DEMOLITION AND/OR CONSTRUCTION.
- PRIOR TO DEMOLITION, INVESTIGATE WALLS FOR CONCEALED PIPING AND INFORM OWNER/ARCHITECT OF ANY CONDITION NOT DOCUMENTED IN CONTRACT DRAWINGS. DEMO DESIGNATED WALL BASES, WALL FRAMING, BATT INSULATION AND GYPSUM BOARD, DEMO CONDUITS AND RECEPTACLES, REFERENCE ELECTRICAL DEMO PLAN FOR ADDITIONAL INFORMATION.

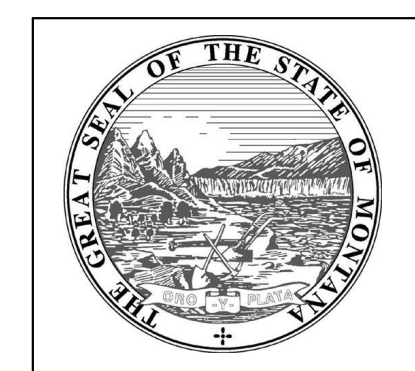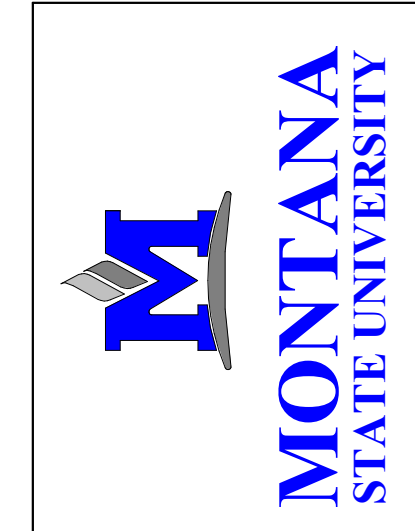

MSU-CPDC  
MONTANA STATE UNIVERSITY  
BOZEMAN, MONTANA  
PHONE: 406.994.5413  
FAX: 406.994.5665

MSU PAISLEY COURT  
HOUSING

BID/PERMIT SET



DRAWN BY: <b>Author</b>		
REVIEWED BY: <b>Checker</b>		
REV.	DESCRIPTION	DATE
1	Addendum #1	12/18/24

PPA #:	21-0143
A/E #	21-0143
A&E PROJ #:	23123.00

**SHEET TITLE**  
ROOF  
DEMOLITION  
PLAN  
**D2.2**  
  
DATE  
**03/29/24**

DRAWN BY: Author		
REVIEWED BY: Checker		
REV.	DESCRIPTION	DATE

PPA #: 21-0143

A/E #: 21-0143

A&E PROJ #: 23123.00

**SHEET TITLE**  
SITE PLAN

**SHEET**  
**A1.1**

**DATE**  
**03/29/24**

**GENERAL NOTES**


- 101 BUILDING 'B/C' & 102 BUILDING 'B/C' ARE MIRRORED VERSIONS OF TYPICAL BUILDING.

**SITE PLAN LEGEND**

- GUTTER LOCATIONS
- DOWNSPOUT LOCATION

**SITE PLAN NOTES**

- REFER TO ALL DRAWINGS FOR ADDITIONAL INFORMATION. NOTIFY ARCHITECT OF ANY CONFLICT PRIOR TO COMMENCING WORK.
- REFERENCE LANDSCAPE DRAWINGS FOR ADDITIONAL INFORMATION REGARDING SITE WORK.
- REFERENCE LANDSCAPE DRAWINGS FOR LANDSCAPE REQUIREMENTS, LANDSCAPE AREAS, AND ADDITIONAL INFORMATION.

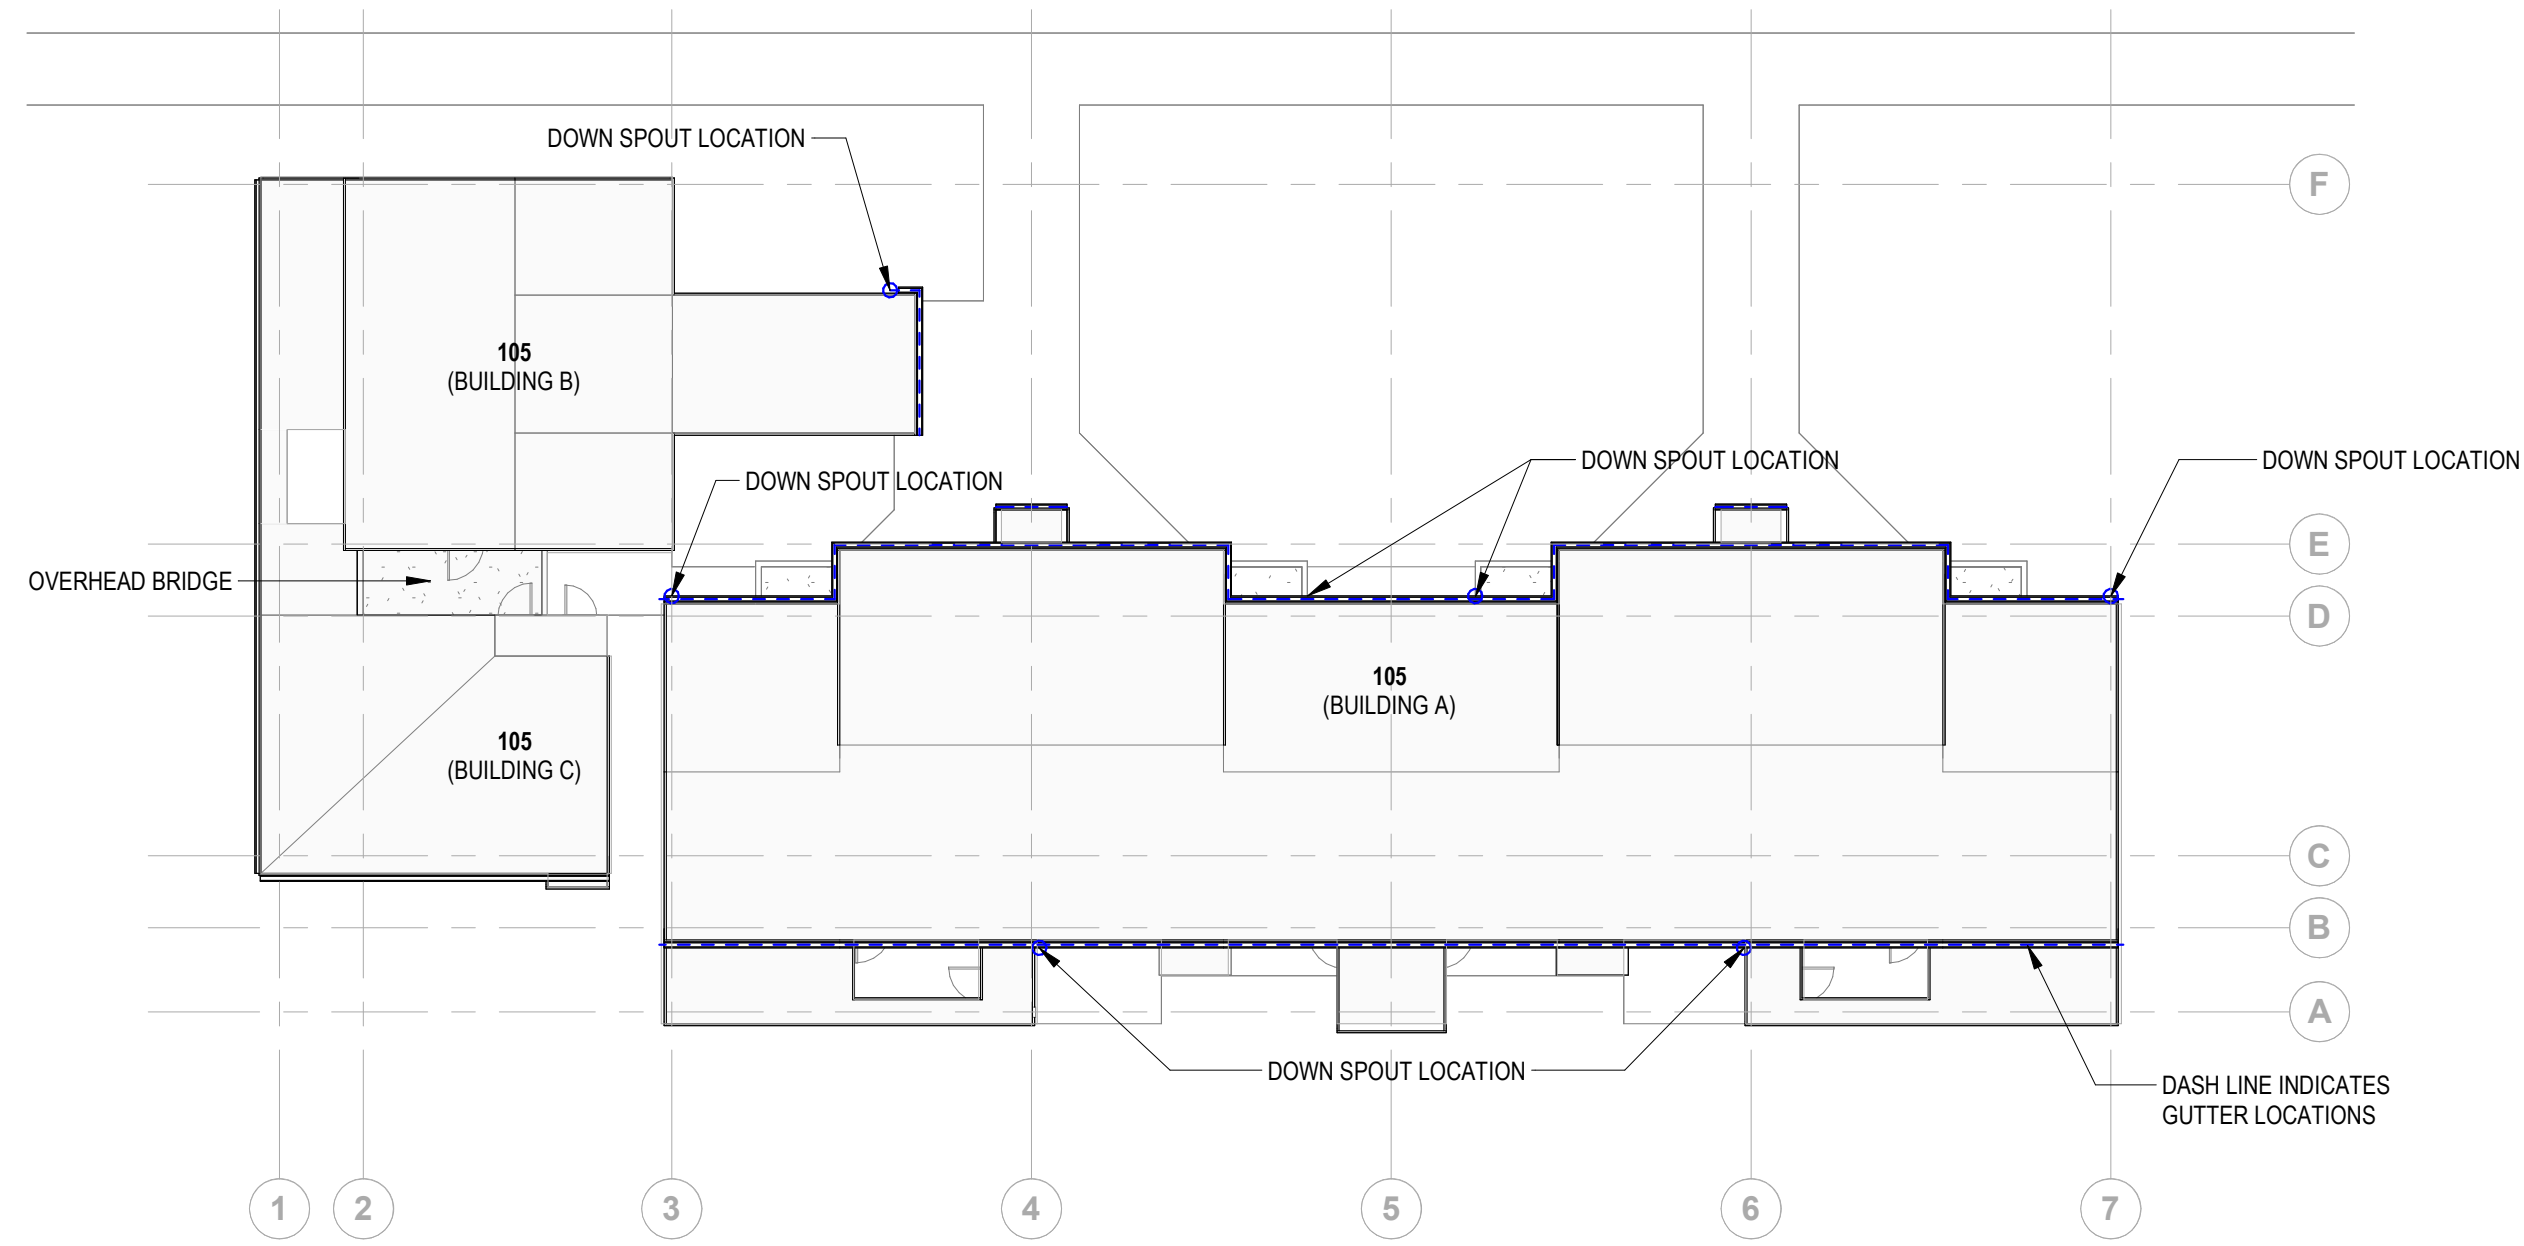

**1** SITE PLAN (TYP)  
1/16" = 1'-0"

NOTE: 101 BUILDING 'B/C' & 102 BUILDING 'B/C' ARE MIRRORED VERSIONS OF TYPICAL BUILDING.




SITE PLAN (TYP)  
REF: A1.1/1



**13** BUILDING LAYOUT  
N.T.S.

NOTE: 101 BUILDING 'B/C' & 102 BUILDING 'B/C' ARE MIRRORED VERSIONS OF TYPICAL BUILDING.




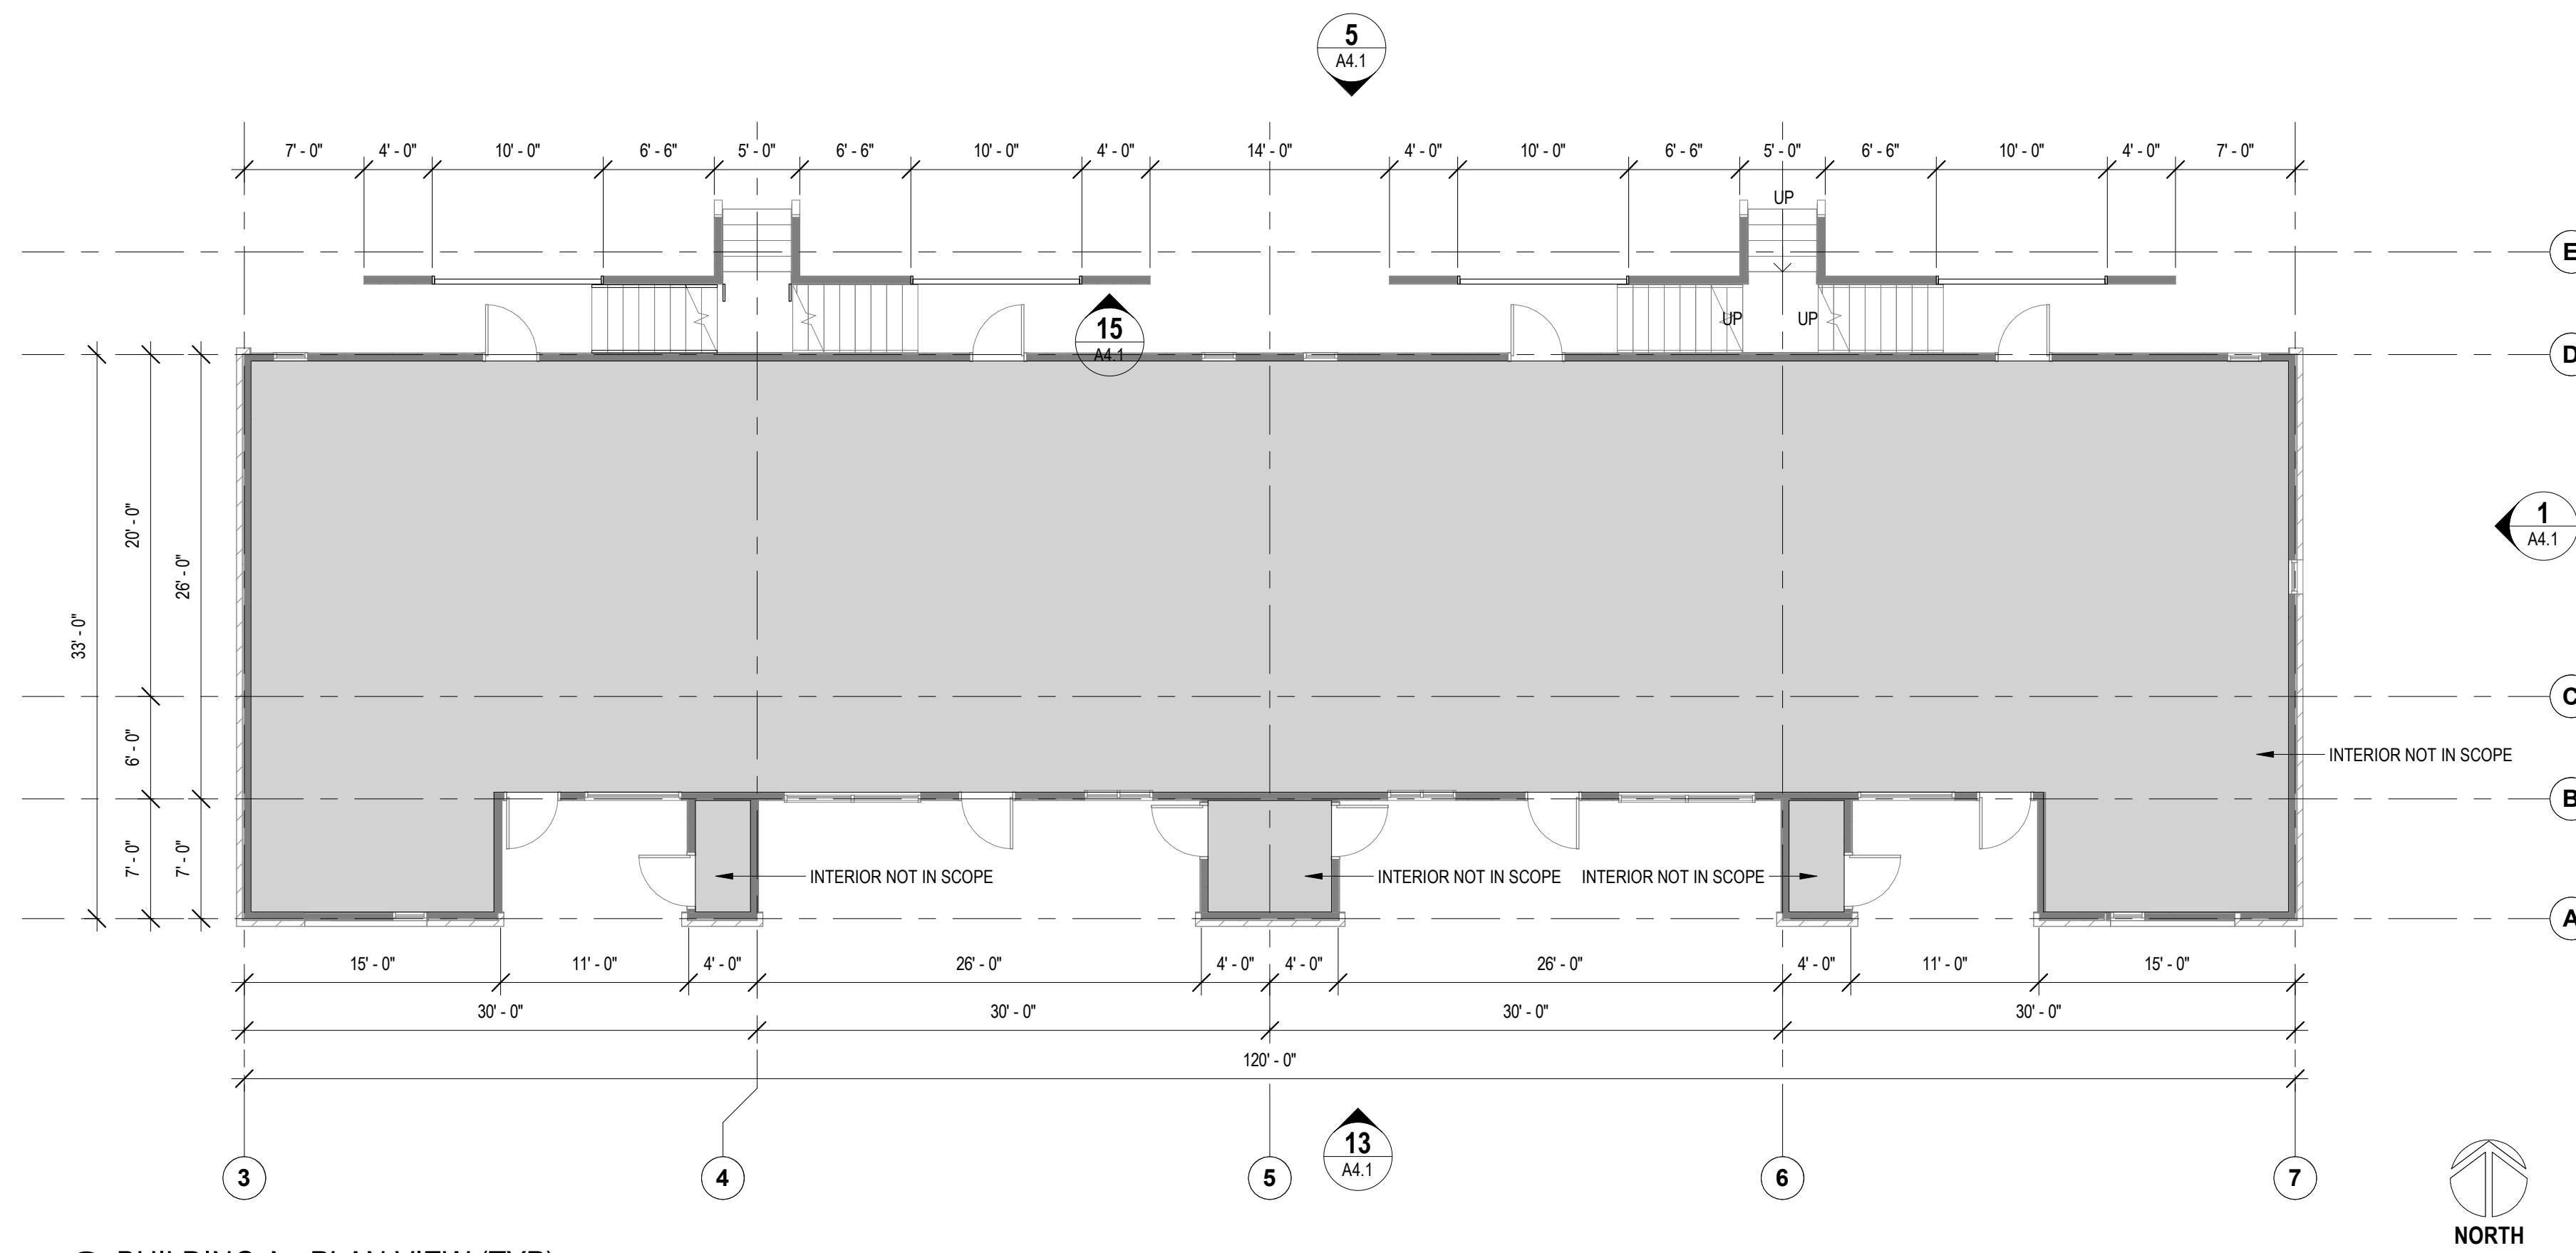


**2** BUILDING A - PLAN VIEW (TYP)  
1/8" = 1'-0"

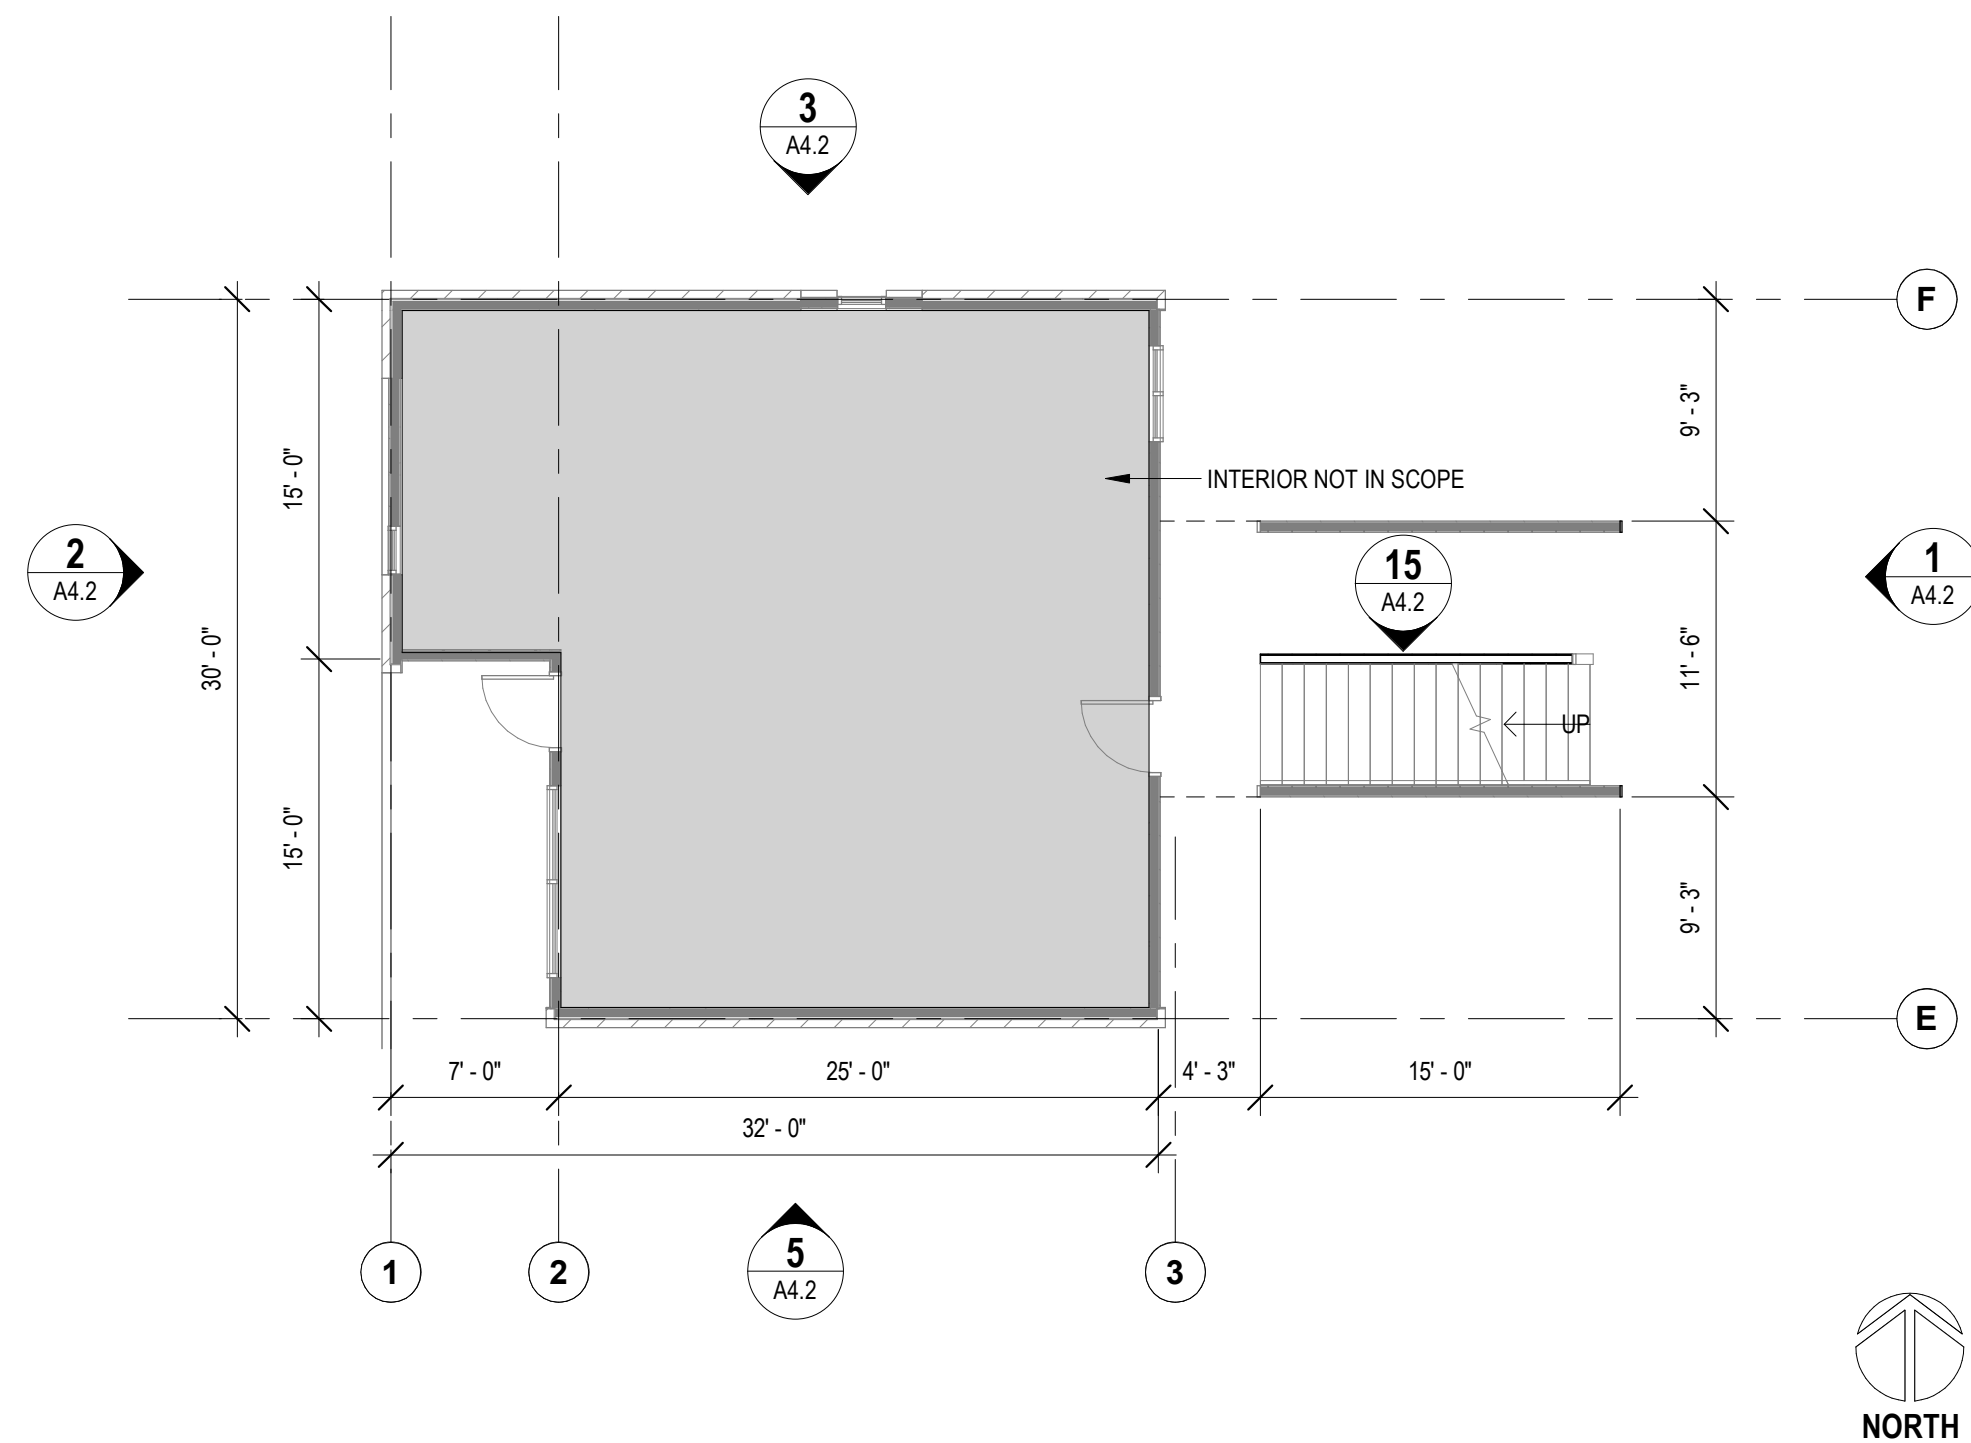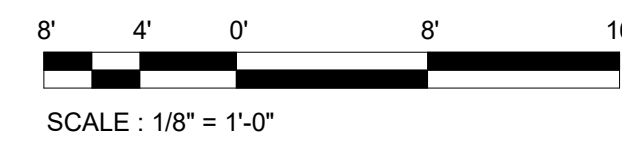


**9** BUILDING B - PLAN VIEW (TYP)  
1/8" = 1'-0"

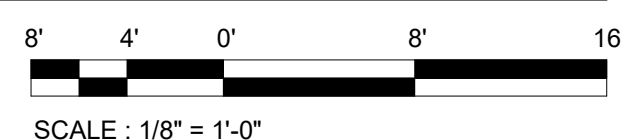

NOTE: FIELD VERIFY ALL DIMENSIONS.  
DO NOT SCALE DRAWINGS.  
NOTE: 101 BUILDING 'B' & 102 BUILDING 'B'  
ARE MIRRORED VERSIONS OF TYPICAL BUILDING.

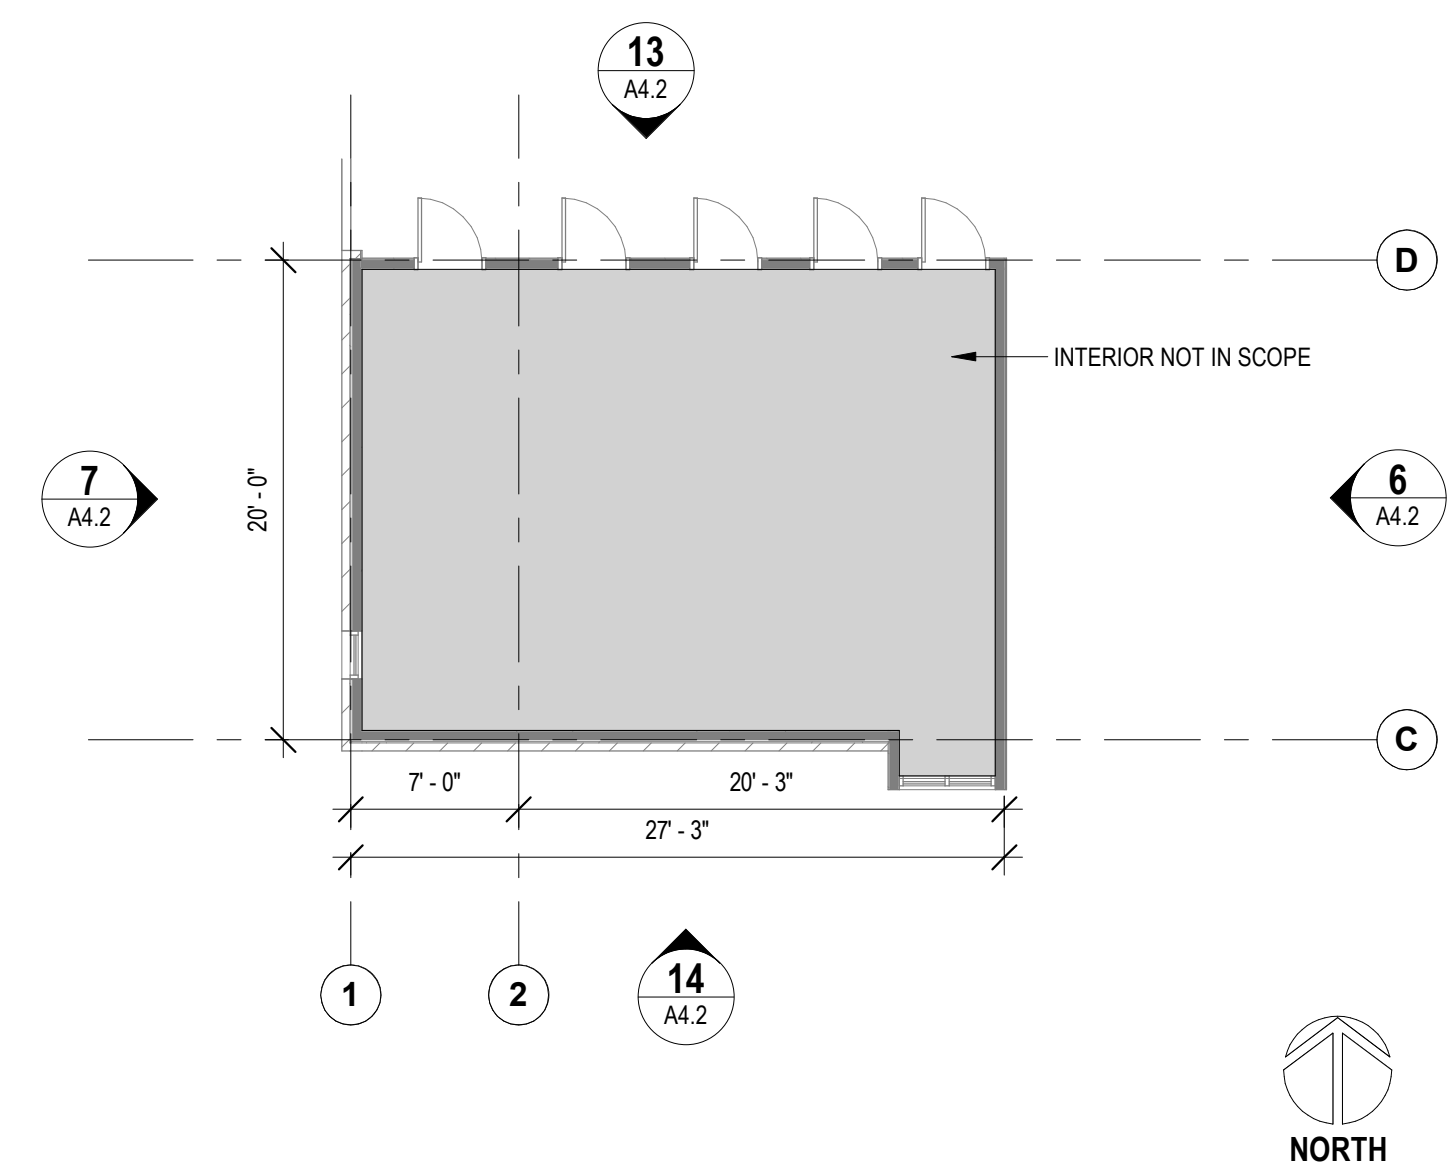

**11** BUILDING C - PLAN VIEW (TYP)  
1/8" = 1'-0"

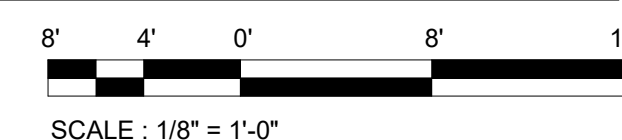

**GENERAL NOTES**

- 101 BUILDING 'B/C' & 102 BUILDING 'B/C' ARE MIRRORED VERSIONS OF TYPICAL BUILDING.

**KEYNOTES**

**FLOOR PLAN NOTES**

1. THE CONTRACTOR SHALL NOT CONSIDER CONSTRUCTION NOTES TO BE ALL-INCLUSIVE. IT IS THE CONTRACTOR'S RESPONSIBILITY TO INSPECT AND ASSESS EACH AREA AND TO FULFILL THE INTENT OF THE CONTRACT DOCUMENTS. CONTRACTOR SHALL COORDINATE ARCHITECTURAL CONSTRUCTION DRAWINGS AND NOTES WITH CIVIL, STRUCTURAL, MECHANICAL, ELECTRICAL, & PLUMBING NOTES AND DRAWINGS AND PROJECT MANUAL.
2. FIELD VERIFY ALL DIMENSIONS. DO NOT SCALE DRAWINGS.
3. ALL FINISHES AND MATERIALS SHALL BE PROPERLY INTEGRATED TO ENSURE A UNIFORM APPEARANCE AND SEAMLESS TRANSITION.
4. ALL DIMENSIONS ARE FROM STRUCTURAL OR UNFINISHED FACE OF STUD, UNLESS OTHERWISE NOTED.
5. PATCH AND REPAIR ANY / ALL WALL SURFACES AS REQUIRED TO PROVIDE SUITABLE SUBSTRATE FOR FINISHES.
6. NOTE: TENANTS WILL OCCUPY THE BUILDINGS. PLEASE SEE NOTICE OF OCCUPANCY LETTER IN THE BID DOCUMENTS.



MSU-CPDC  
MONTANA STATE UNIVERSITY  
BOZEMAN, MONTANA  
PHONE: 406.994.5413  
FAX: 406.994.5665

MSU PAISLEY COURT  
HOUSING

BID/PERMIT SET



DRAWN BY:	Author	
REVIEWED BY:	Checker	
REV.	DESCRIPTION	DATE

PPA #: 21-0143


A/E #: 21-0143

A&E PROJ #: 23123.00

**SHEET TITLE**  
LEVEL 1 FLOOR  
PLAN

**SHEET**  
**A2.1**


**DATE**  
**03/29/24**

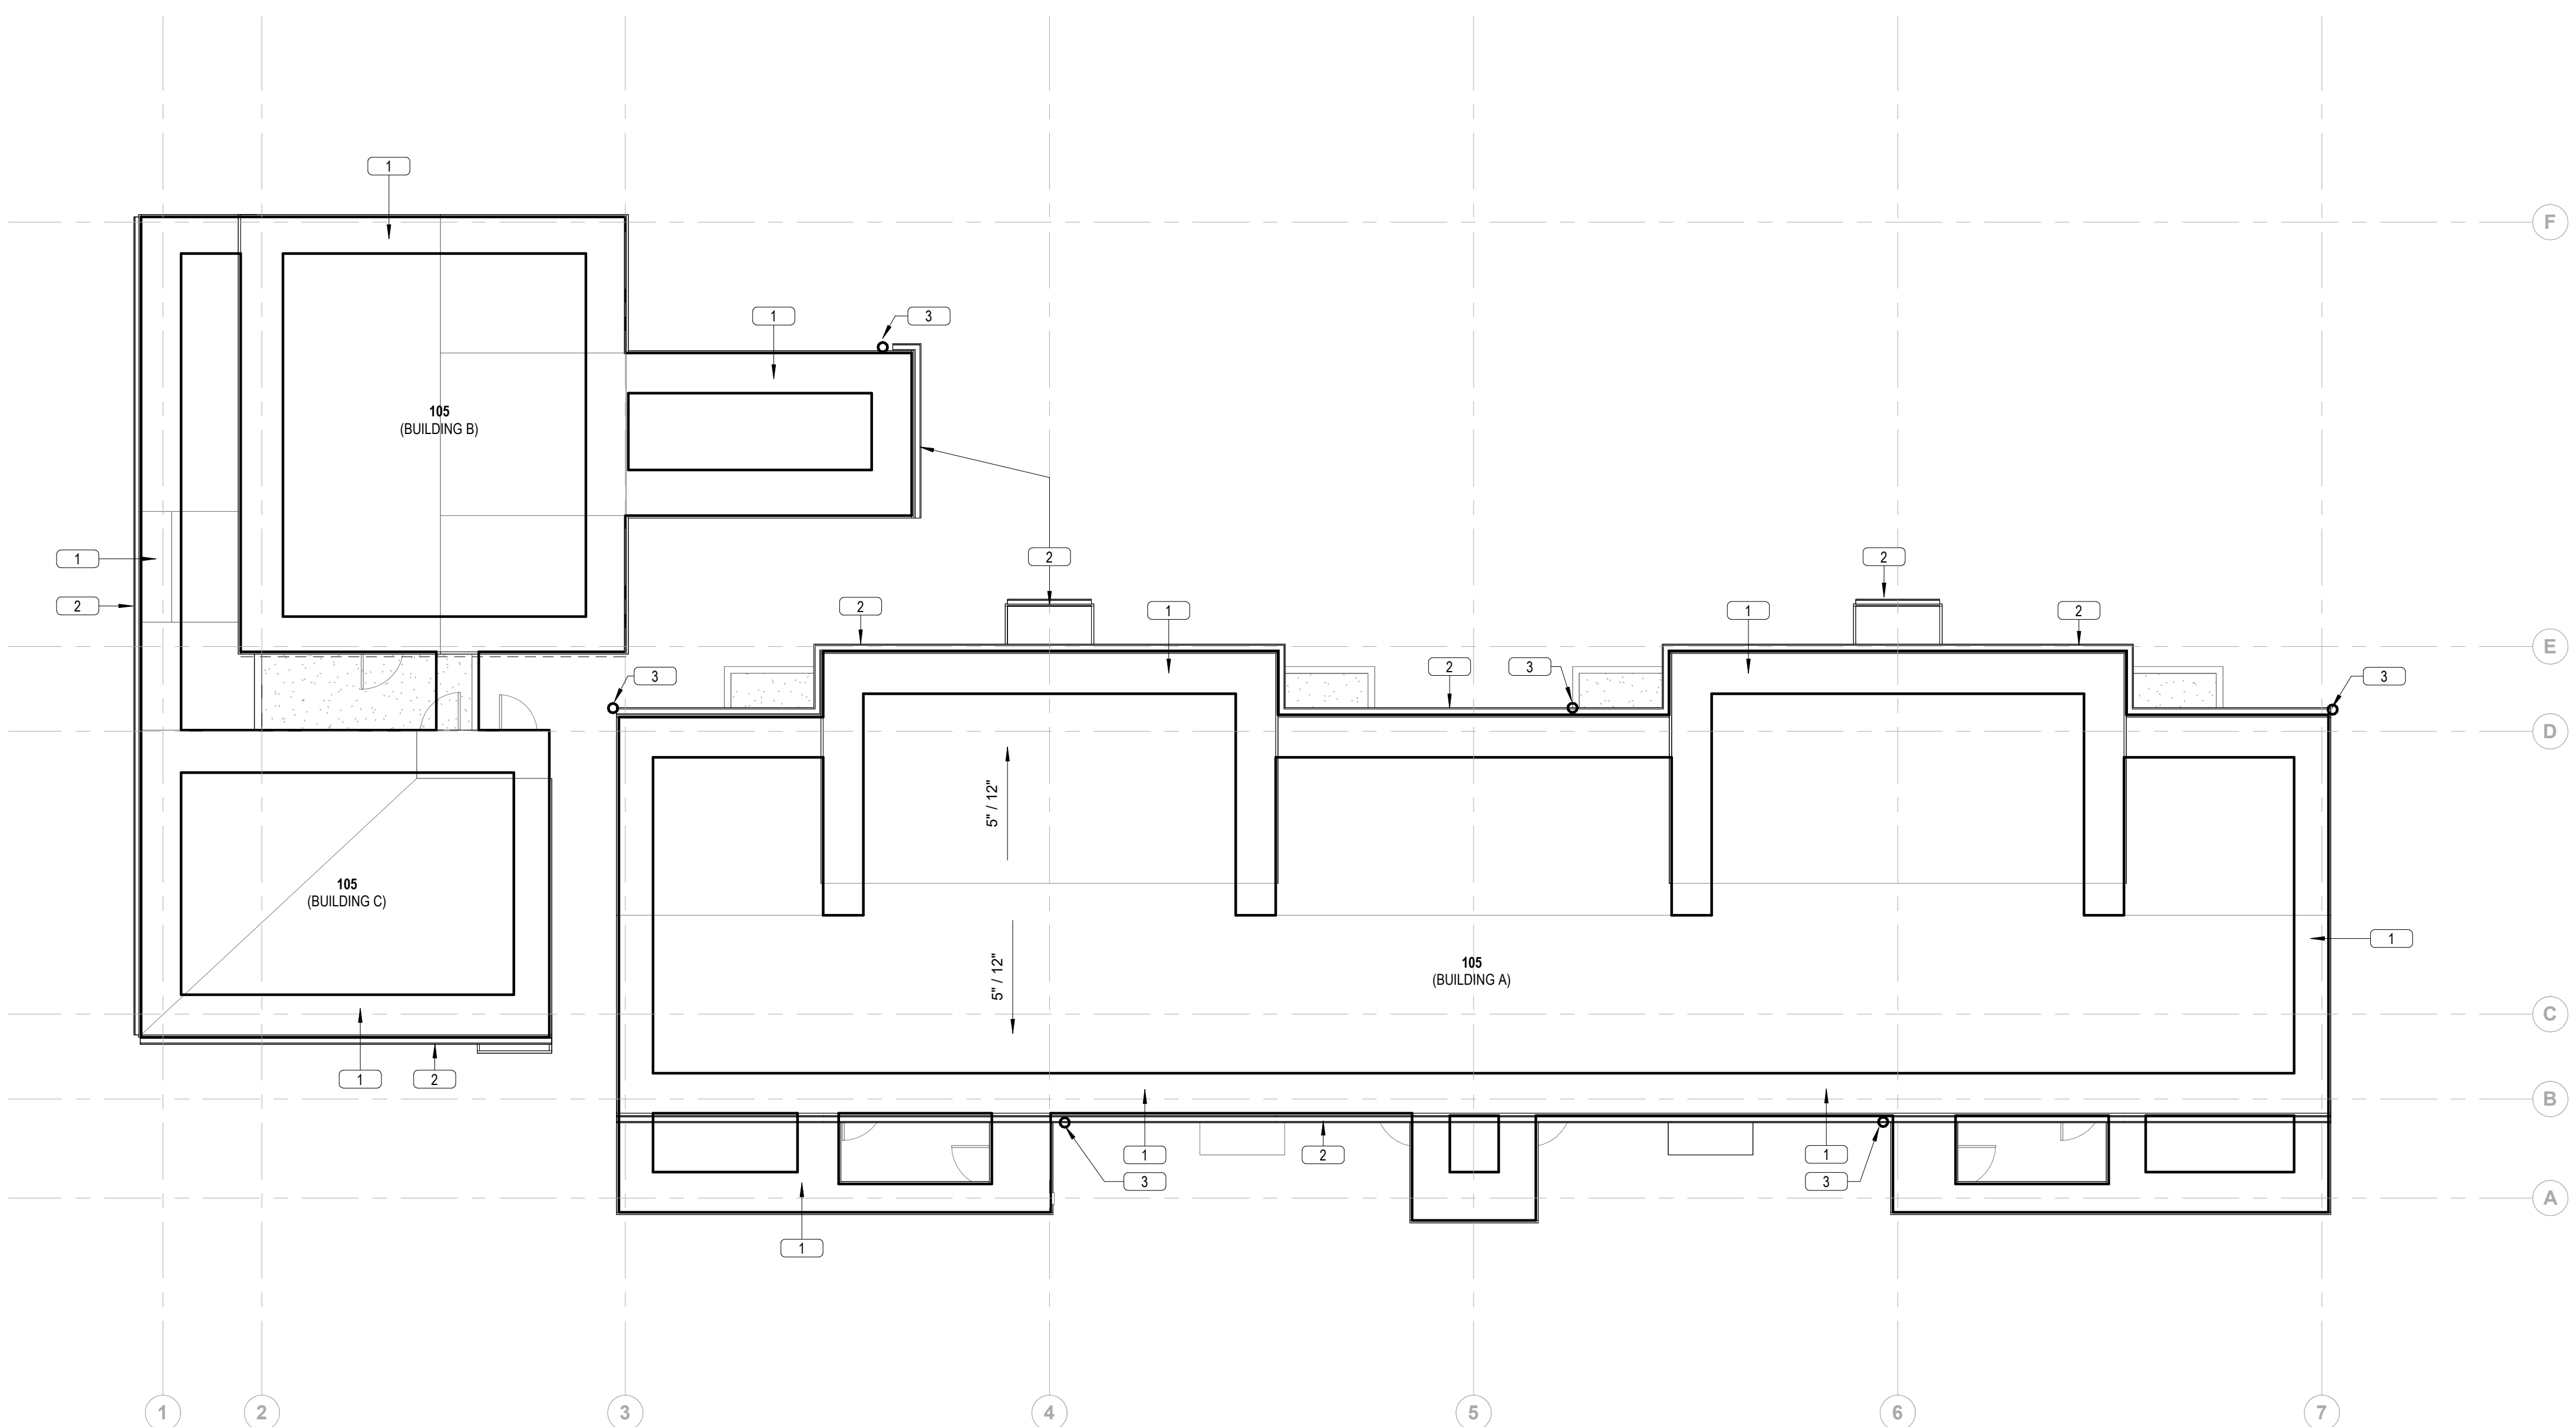

**KEYNOTES**

- 1 ALTERNATE #1: PROVIDE NEW UNDERLAYMENT LAPPED OVER EXISTING AND NEW SHINGLES TO MATCH EXISTING.
- 2 PROVIDE AND INSTALL NEW GUTTER.
- 3 PROVIDE AND INSTALL NEW DOWNSPOUT AT THIS LOCATION.

**1** ROOF  
1/8" = 1'-0"

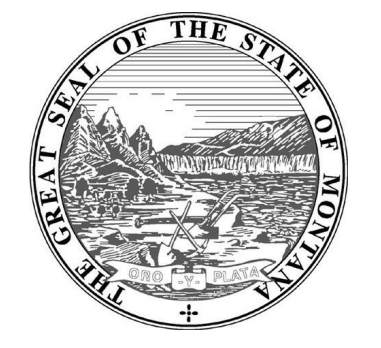

MSU-CPDC  
MONTANA STATE UNIVERSITY  
BOZEMAN, MONTANA  
PHONE: 406.994.5413  
FAX: 406.994.5665

MSU PAISLEY COURT  
HOUSING

BID/PERMIT SET



DRAWN BY:	Author	
REVIEWED BY:	Checker	
REV.	DESCRIPTION	DATE

PPA #:	21-0143
A/E #	21-0143
A&E PROJ #:	23123.00

**SHEET TITLE**  
ROOF PLAN

**SHEET**  
**A2.2**

**DATE**  
**03/29/24**

### MATERIAL LEGEND


- HARDIE PLANK LAP SIDING**  
TEXTURE: SELECT CEDARMILL  
COLOR: WEATHERED CLIFFS  
WIDTH: 7.25"
- HARDIE PANEL VERTICAL SIDING**  
TEXTURE: SELECT CEDARMILL  
COLOR: ARCTIC WHITE  
WIDTH: 48"
- HARDIE SOFFIT PANEL**  
TEXTURE: VENTED SMOOTH  
COLOR: WEATHERED CLIFFS  
WIDTH: 16"
- HARDIE TRIM BOARD**  
TEXTURE: 5/4 RUSTIC  
COLOR: COBBLE STONE  
WIDTH: 11.25"
- SHERWIN-WILLIAMS**  
TEXTURE: DURATION EXTERIOR  
COLOR: SW 9695 (BETROOT)

### GENERAL NOTES

1. WINDOWS ON BUILDINGS 104 & 109 ELEVATION NORTH ARE NOT TYPICAL. USE WINDOW TYPE 'C' AS ALTERNATE (REF. SCHEDULE).

### ELEVATION NOTES


1. ALL INFORMATION REGARDING EXISTING CONDITIONS IS BASED UPON OWNER-SUPPLIED DOCUMENTS AND MAY NOT PRECISELY REFLECT FIELD CONDITIONS.
2. THE CONTRACTOR SHALL NOT CONSIDER CONSTRUCTION NOTES TO BE ALL-INCLUSIVE. IT IS THE CONTRACTOR'S RESPONSIBILITY TO INSPECT AND ASSESS EACH AREA AND TO FULFILL THE INTENT OF THE CONTRACT DOCUMENTS. CONTRACTOR SHALL COORDINATE ARCHITECTURAL CONSTRUCTION DRAWING AND NOTES WITH CIVIL, STRUCTURAL AND MECHANICAL, ELECTRICAL & PLUMBING NOTES AND DRAWINGS.
3. FIELD VERIFY ALL DIMENSIONS. DO NOT SCALE DRAWINGS.
4. ALL FINISHES AND MATERIALS SHALL BE PROPERLY INTEGRATED TO ENSURE A UNIFORM APPEARANCE AND SEAMLESS TRANSITION.
5. ALL DIMENSIONS ARE FROM STRUCTURAL OR UNFINISHED FACE OF STUD, UNLESS OTHERWISE NOTED.
6. GENERAL CONTRACTOR SHALL COORDINATE ALL ASPECTS OF THE BUILDING CONSTRUCTION.
7. PATCH AND REPAIR ANY / ALL WALL SURFACES AS REQUIRED TO PROVIDE SUITABLE SUBSTRATE FOR FINISHES.
8. U.L. ASSEMBLIES DESCRIBED ARE FOR REFERENCE ONLY. THE GENERAL CONTRACTOR SHALL COORDINATE AND VERIFY THE INSTALLATION OF THE DESCRIBED SYSTEM(S).

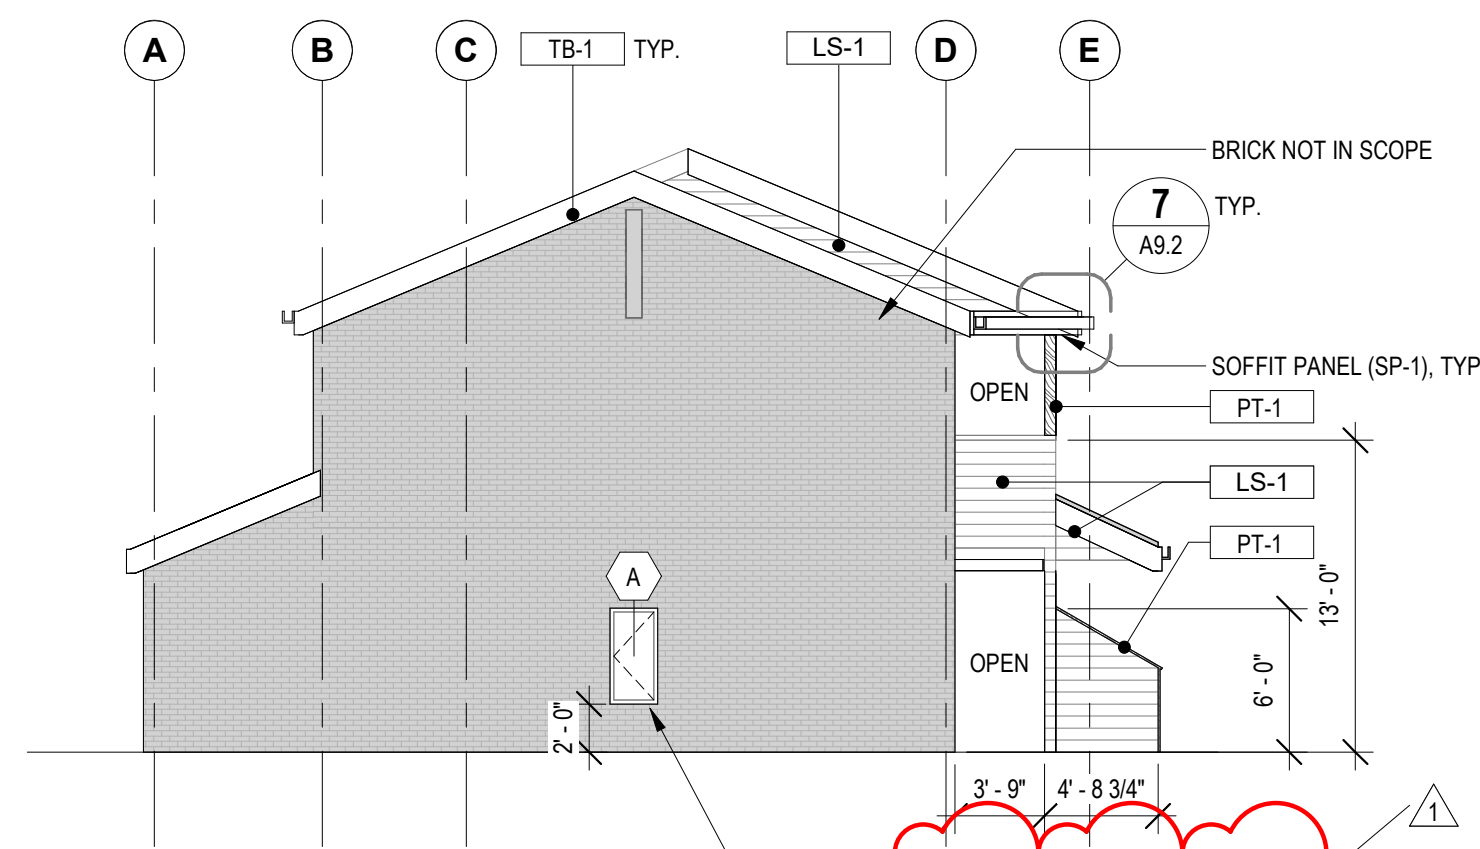

**1 BUILDING A - ELEVATION EAST (TYP)**

1/8" = 1'-0"


NOTE: FIELD VERIFY ALL DIMENSIONS. DO NOT SCALE DRAWINGS.  
NOTE: REFERENCE A1.1-1 FOR GUTTER LOCATIONS

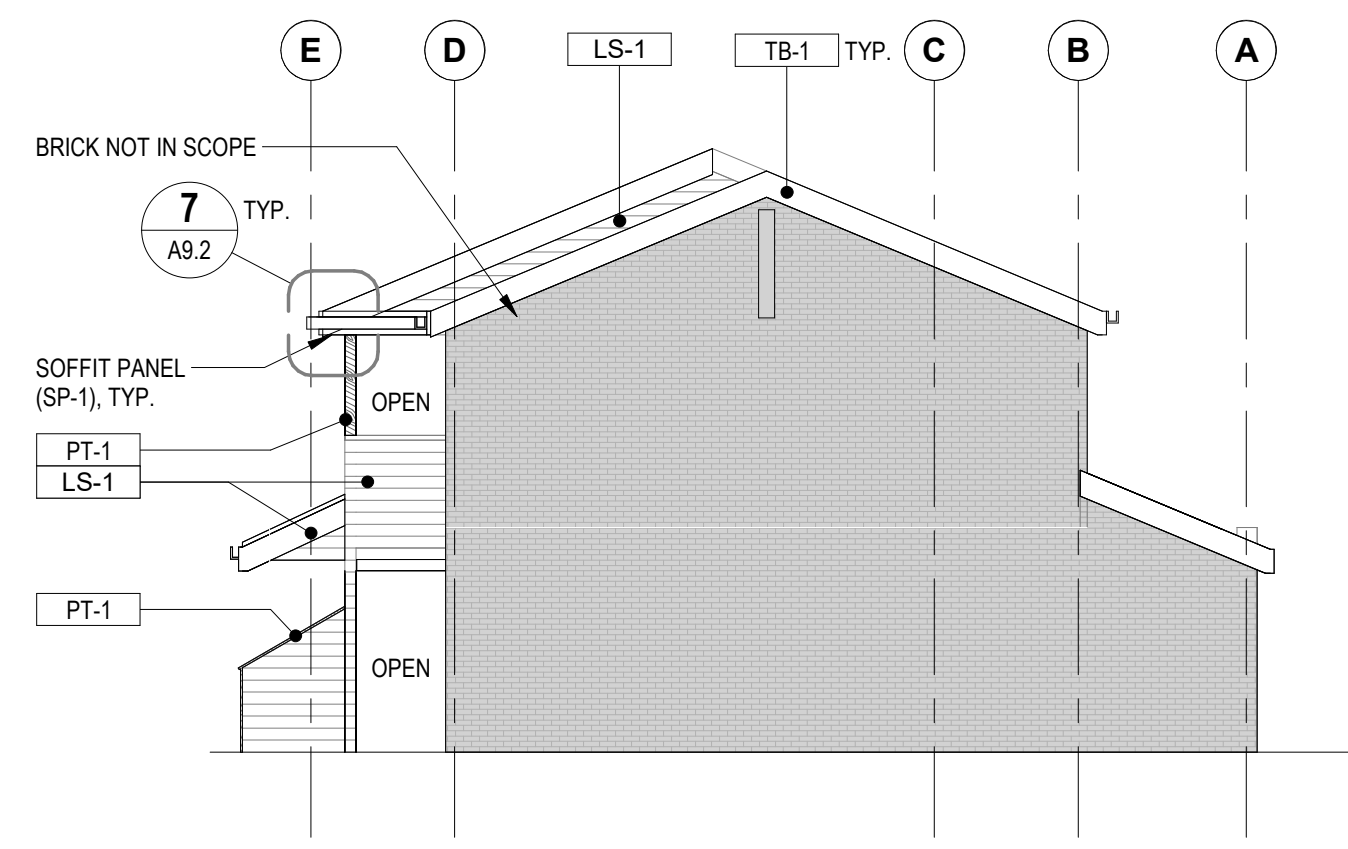

**3 BUILDING A - ELEVATION WEST (TYP)**

1/8" = 1'-0"


NOTE: FIELD VERIFY ALL DIMENSIONS. DO NOT SCALE DRAWINGS.  
NOTE: REFERENCE A1.1-1 FOR GUTTER LOCATIONS

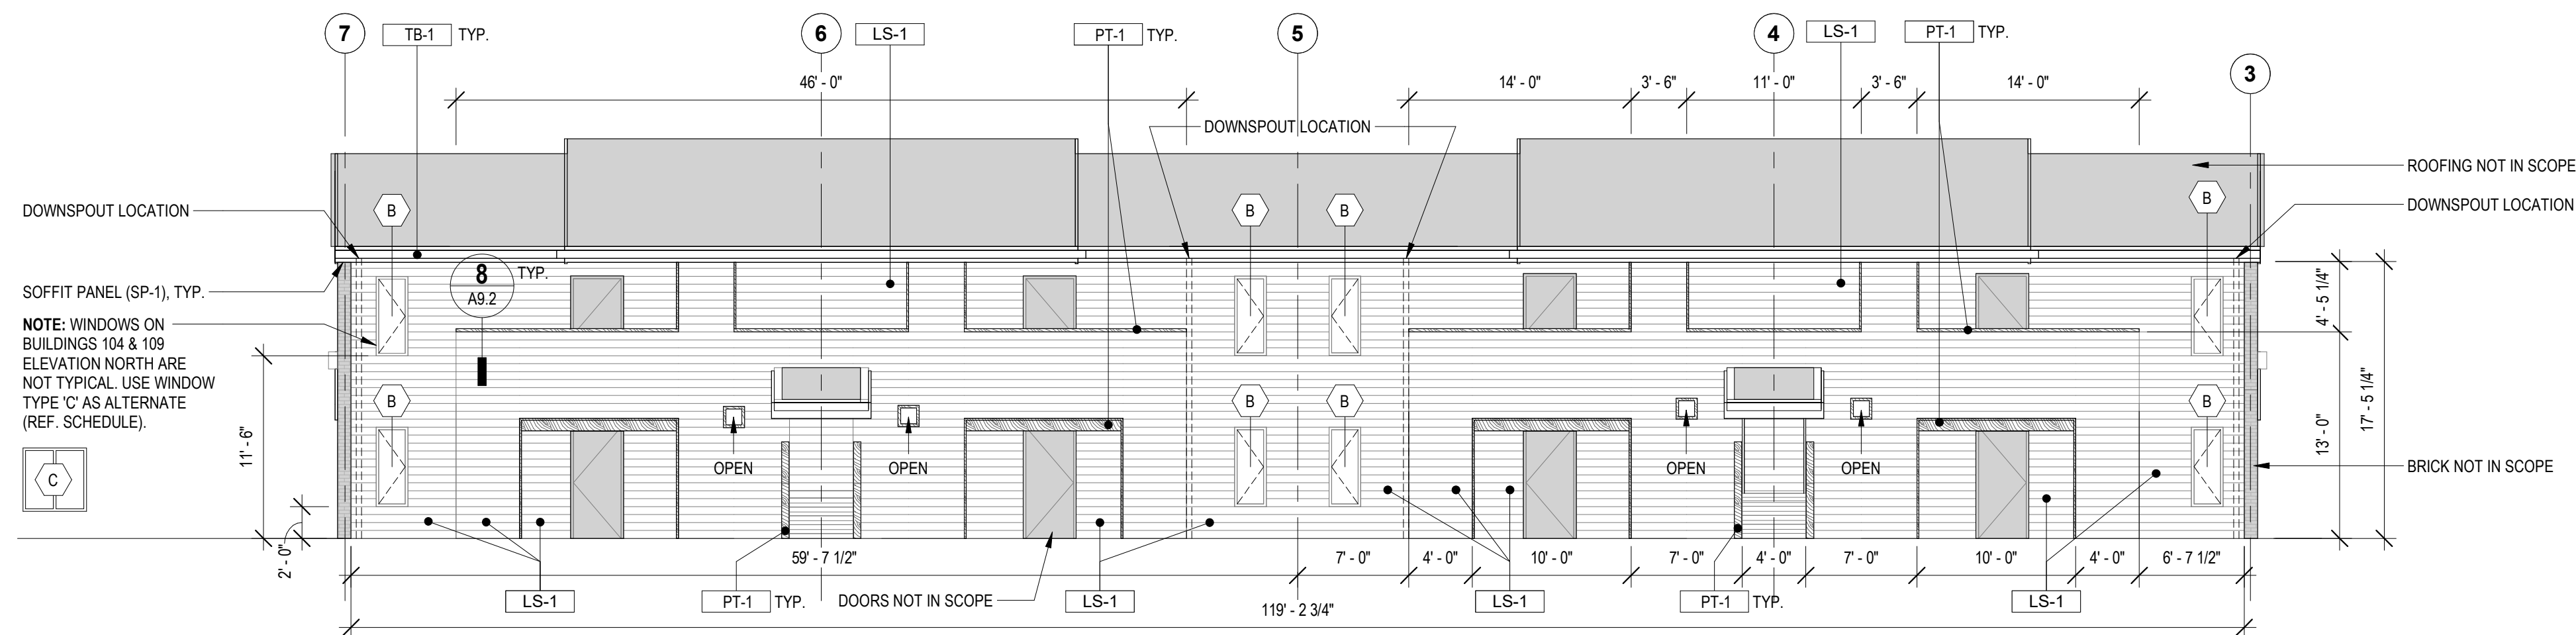

**5 BUILDING A - ELEVATION NORTH (TYP)**

1/8" = 1'-0"


NOTE: FIELD VERIFY ALL DIMENSIONS. DO NOT SCALE DRAWINGS.  
NOTE: REFERENCE A1.1-1 FOR GUTTER LOCATIONS

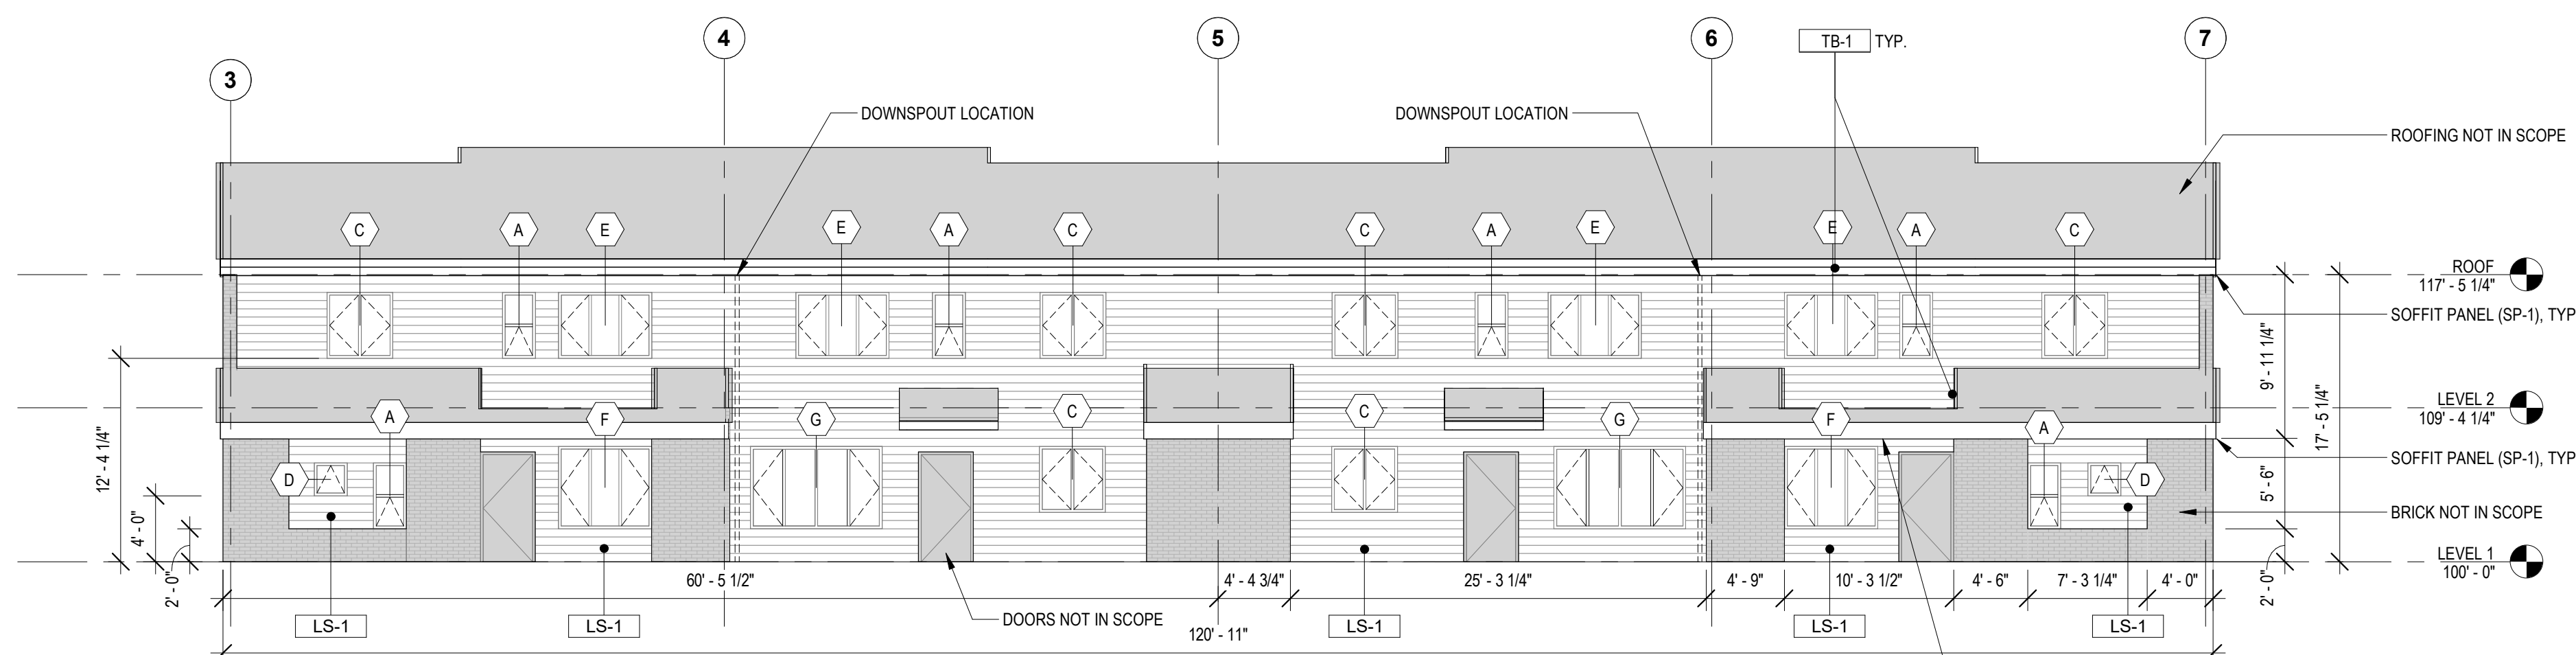

**13 BUILDING A - ELEVATION SOUTH (TYP)**

1/8" = 1'-0"

NOTE: FIELD VERIFY ALL DIMENSIONS. DO NOT SCALE DRAWINGS.  
NOTE: REFERENCE A1.1-1 FOR GUTTER LOCATIONS

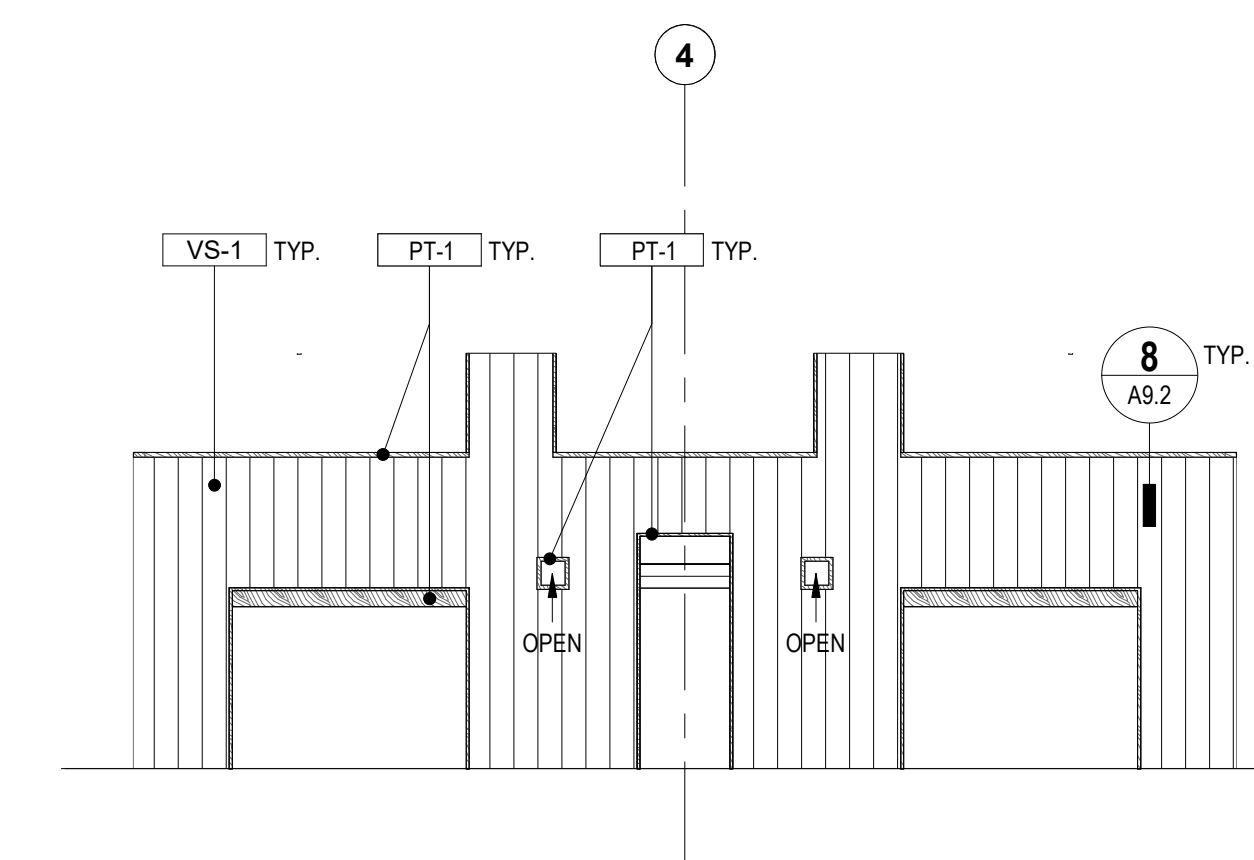

**15 BUILDING A - ELEVATION BACKSIDE ENTRY WALL (TYP)**

1/8" = 1'-0"

NOTE: FIELD VERIFY ALL DIMENSIONS. DO NOT SCALE DRAWINGS.


DRAWN BY: <b>Author</b>	
REVIEWED BY: <b>Checker</b>	
REV.	DESCRIPTION
1	Addendum #1

PPA #:	21-0143
A/E #:	21-0143
A&E PROJ #:	23123.00

<b>SHEET TITLE</b>	
EXTERIOR ELEVATIONS	
SHEET	
<b>A4.1</b>	
DATE	
03/29/24	


BID/PERMIT SET



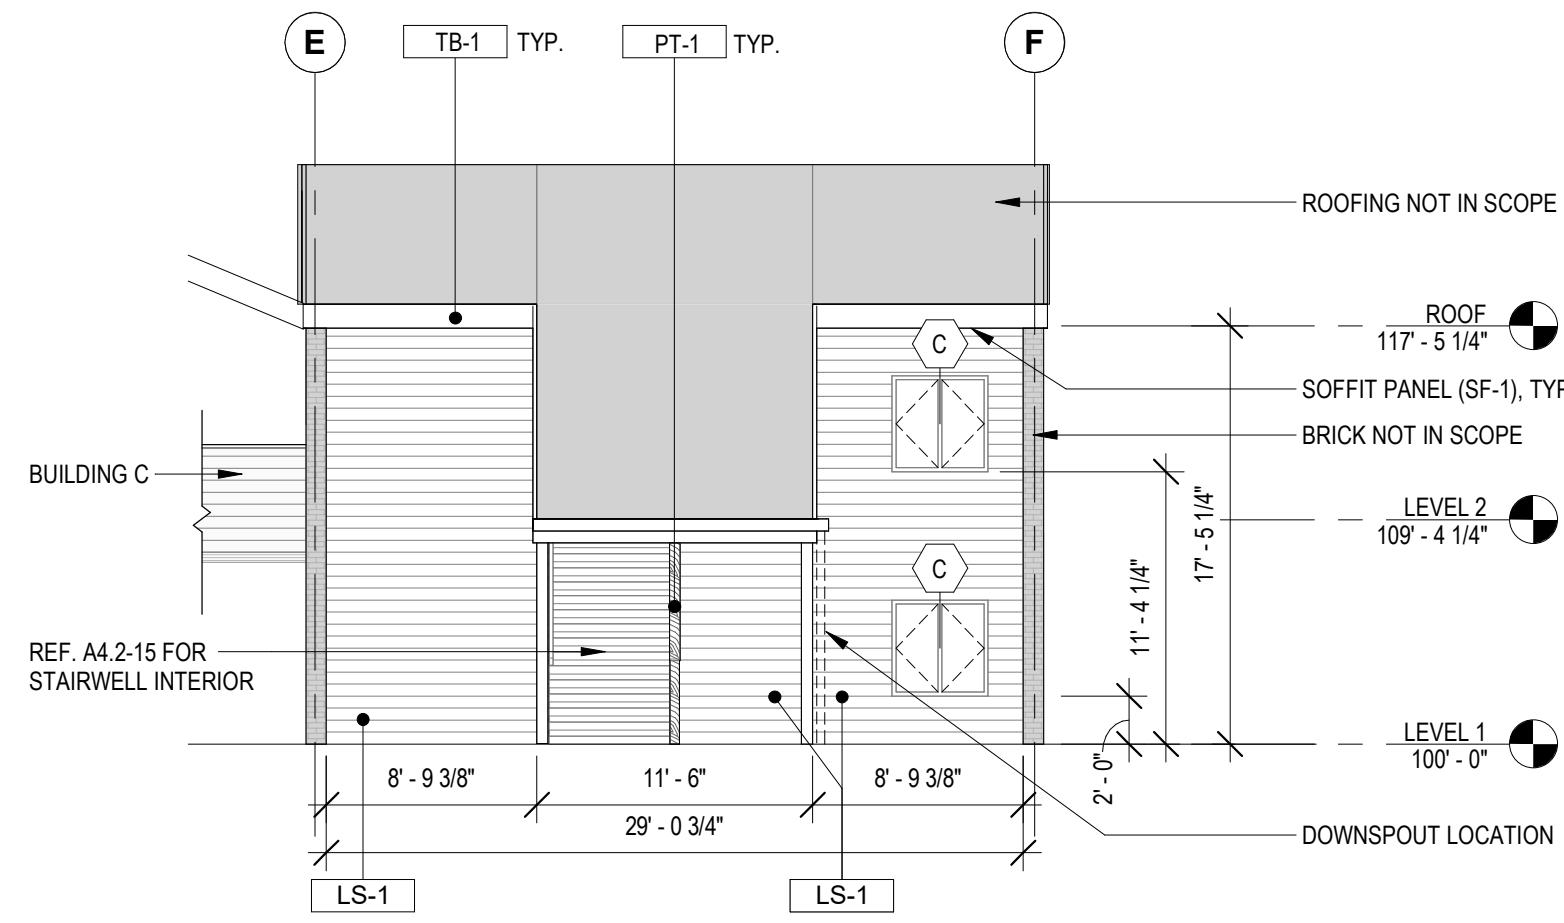


**1 BUILDING B - ELEVATION EAST (TYP)**  
1/8" = 1'-0"

NOTE: FIELD VERIFY ALL DIMENSIONS. DO NOT SCALE DRAWINGS.  
NOTE: 101 BUILDING 'B' & 102 BUILDING 'B' ARE MIRRORED VERSIONS OF TYPICAL BUILDING.

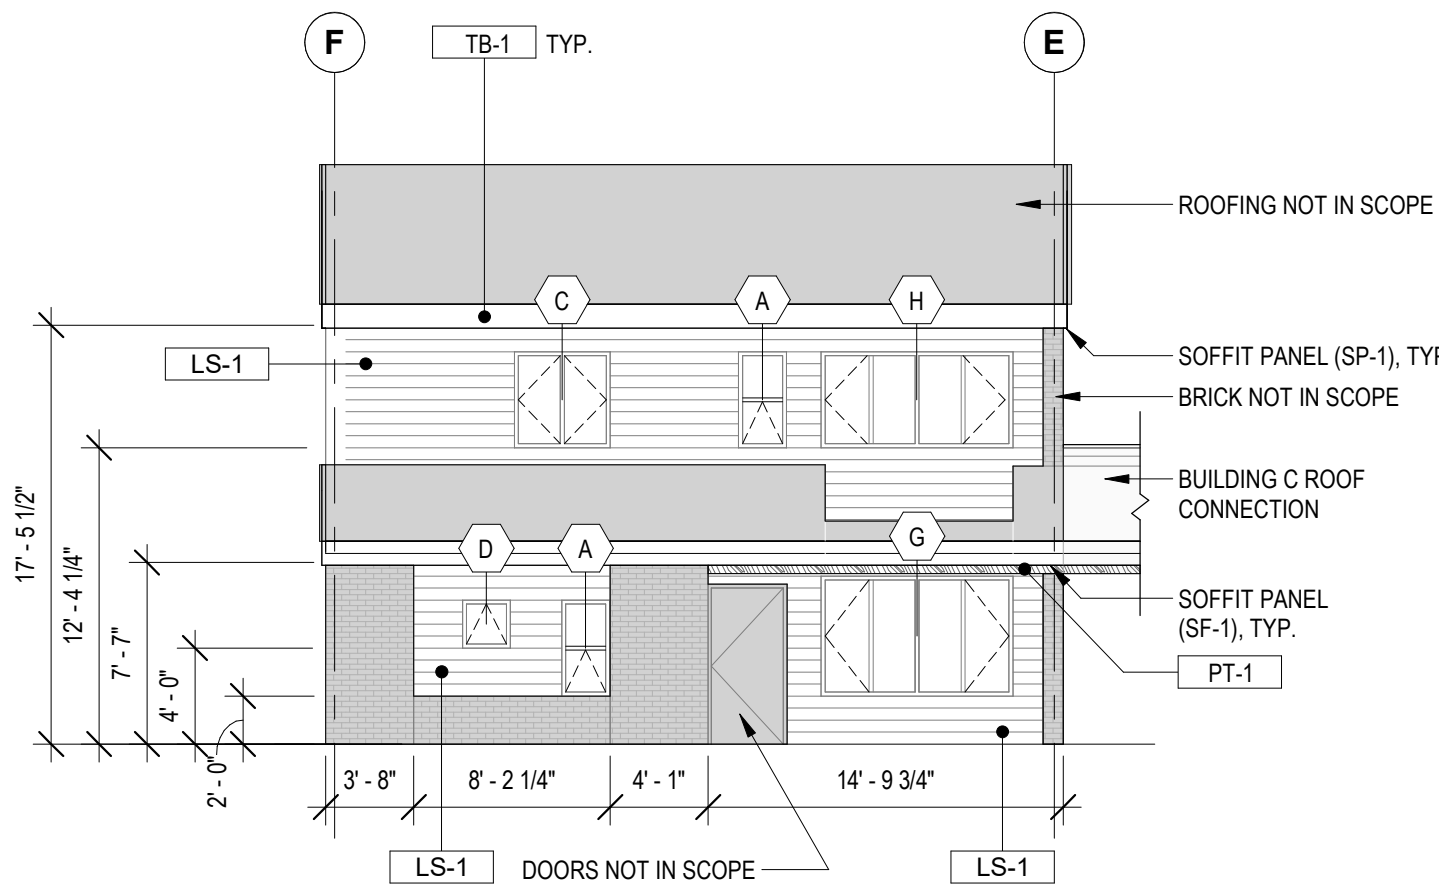

**2 BUILDING B - ELEVATION WEST (TYP)**  
1/8" = 1'-0"

NOTE: FIELD VERIFY ALL DIMENSIONS. DO NOT SCALE DRAWINGS.  
NOTE: 101 BUILDING 'B' & 102 BUILDING 'B' ARE MIRRORED VERSIONS OF TYPICAL BUILDING.

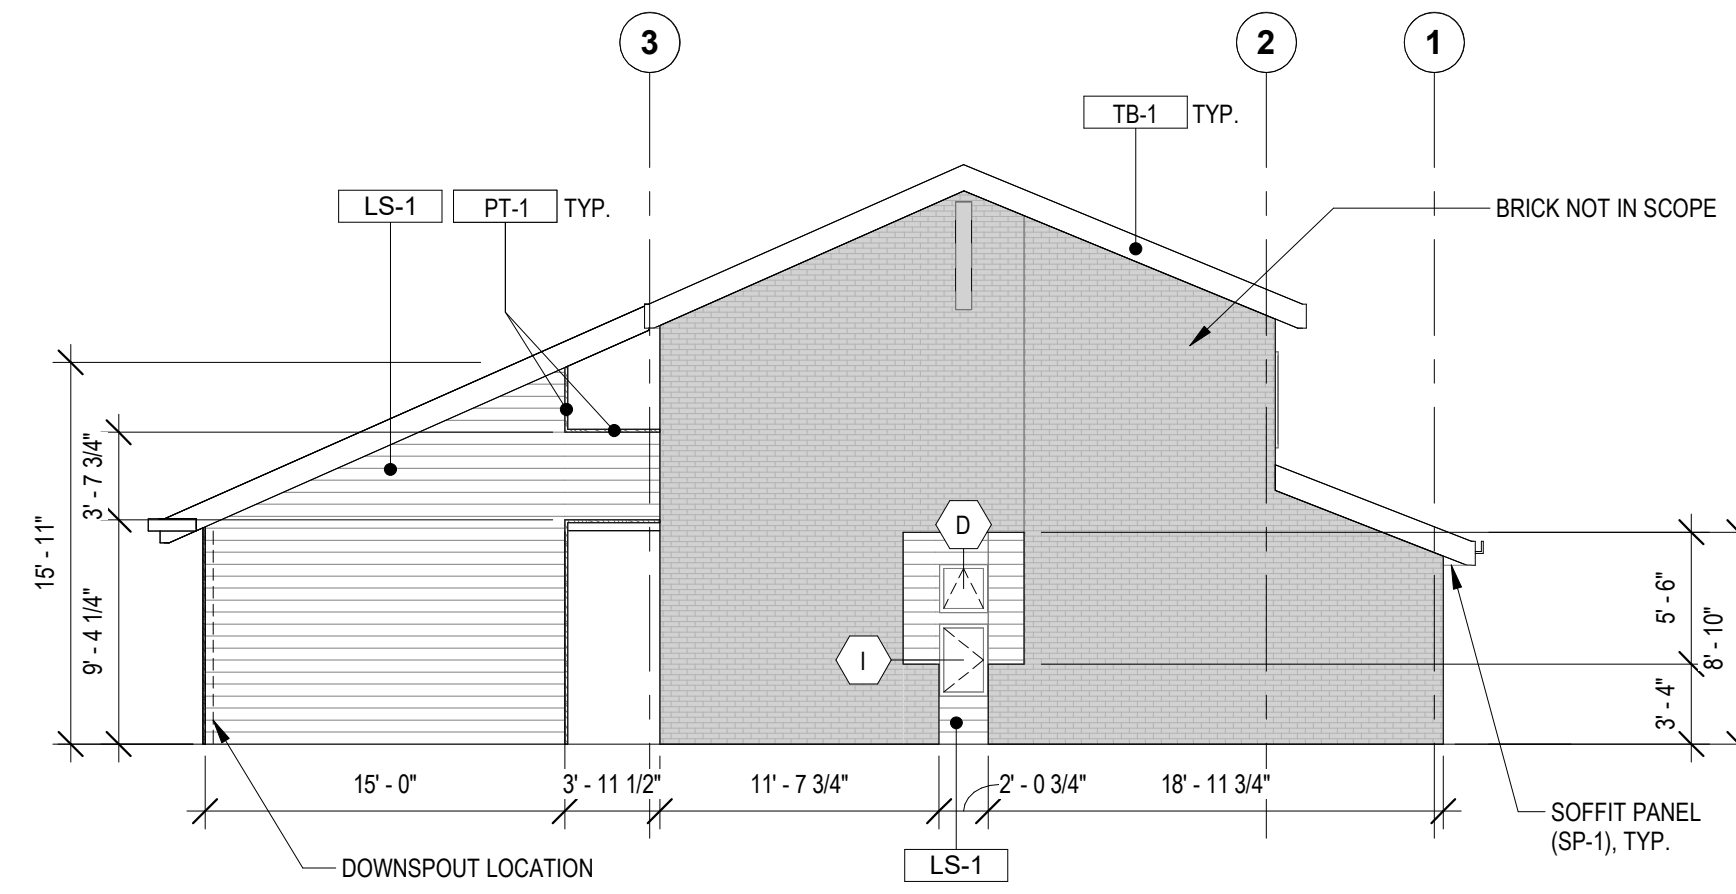

**3 BUILDING B - ELEVATION NORTH (TYP)**  
1/8" = 1'-0"


NOTE: FIELD VERIFY ALL DIMENSIONS. DO NOT SCALE DRAWINGS.  
NOTE: 101 BUILDING 'B' & 102 BUILDING 'B' ARE MIRRORED VERSIONS OF TYPICAL BUILDING.  
NOTE: REFERENCE A1.1-1 FOR GUTTER LOCATIONS

**GENERAL NOTES**

- LS-1 HARDIE PLANK LAP SIDING  
TEXTURE: SELECT CEDARMILL  
COLOR: WEATHERED CLIFFS  
WIDTH: 7.25"
- VS-1 HARDIE PANEL VERTICAL SIDING  
TEXTURE: SELECT CEDARMILL  
COLOR: ARCTIC WHITE  
WIDTH: 48"
- SP-1 HARDIE SOFFIT PANEL  
TEXTURE: VENTED SMOOTH  
COLOR: WEATHERED CLIFFS  
WIDTH: 16"
- TB-1 HARDIE TRIM BOARD  
TEXTURE: 5/4 RUSTIC  
COLOR: COBBLE STONE  
WIDTH: 11.25"
- PT-1 SHERWIN-WILLIAMS  
TEXTURE: DURATION EXTERIOR  
COLOR: SW 9695 (BETROOT)


**GENERAL NOTES**

1. 101 BUILDING 'B/C' & 102 BUILDING 'B/C' ARE MIRRORED VERSIONS OF TYPICAL BUILDING.

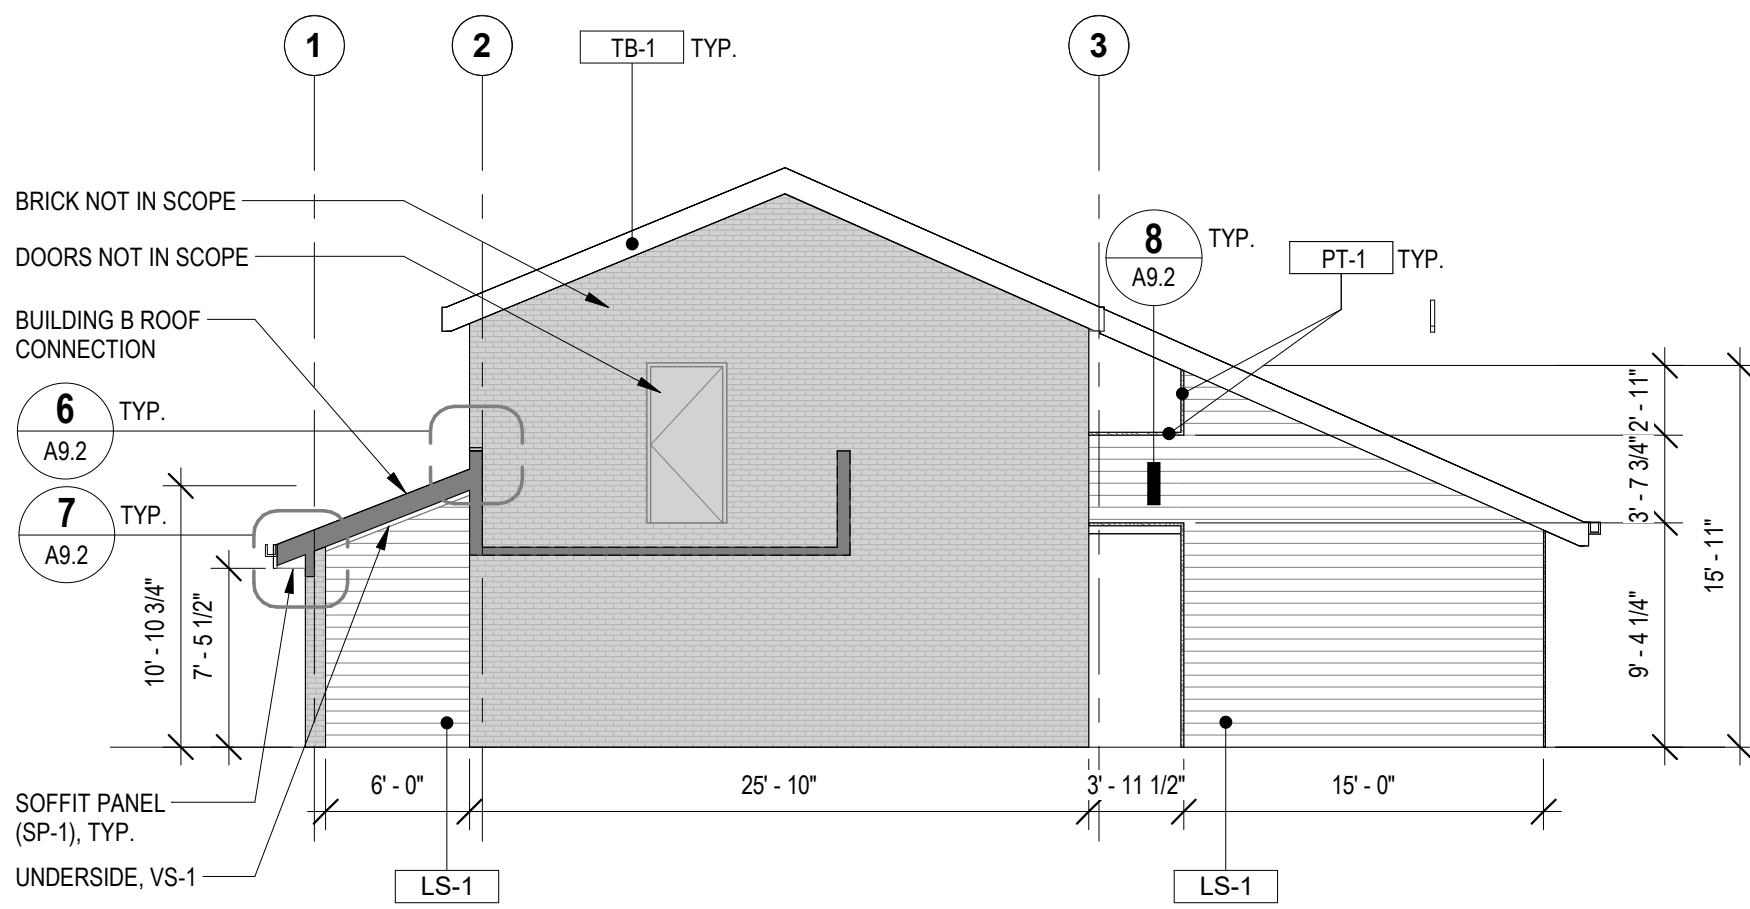


**5 BUILDING B - ELEVATION SOUTH (TYP)**  
1/8" = 1'-0"

NOTE: FIELD VERIFY ALL DIMENSIONS. DO NOT SCALE DRAWINGS.  
NOTE: 101 BUILDING 'B' & 102 BUILDING 'B' ARE MIRRORED VERSIONS OF TYPICAL BUILDING.  
NOTE: REFERENCE A1.1-1 FOR GUTTER LOCATIONS

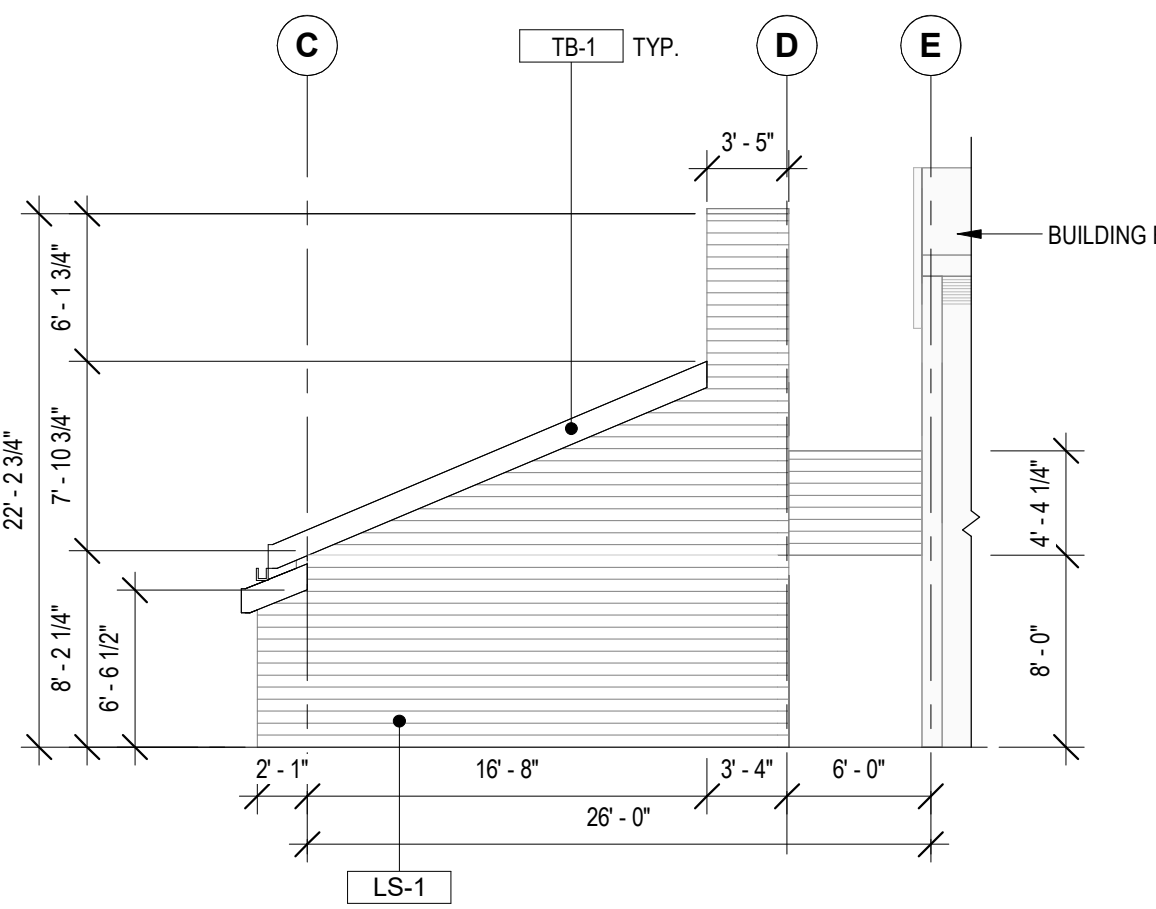

**6 BUILDING C - ELEVATION EAST (TYP)**  
1/8" = 1'-0"

NOTE: FIELD VERIFY ALL DIMENSIONS. DO NOT SCALE DRAWINGS.  
NOTE: 101 BUILDING 'C' & 102 BUILDING 'C' ARE MIRRORED VERSIONS OF TYPICAL BUILDING.

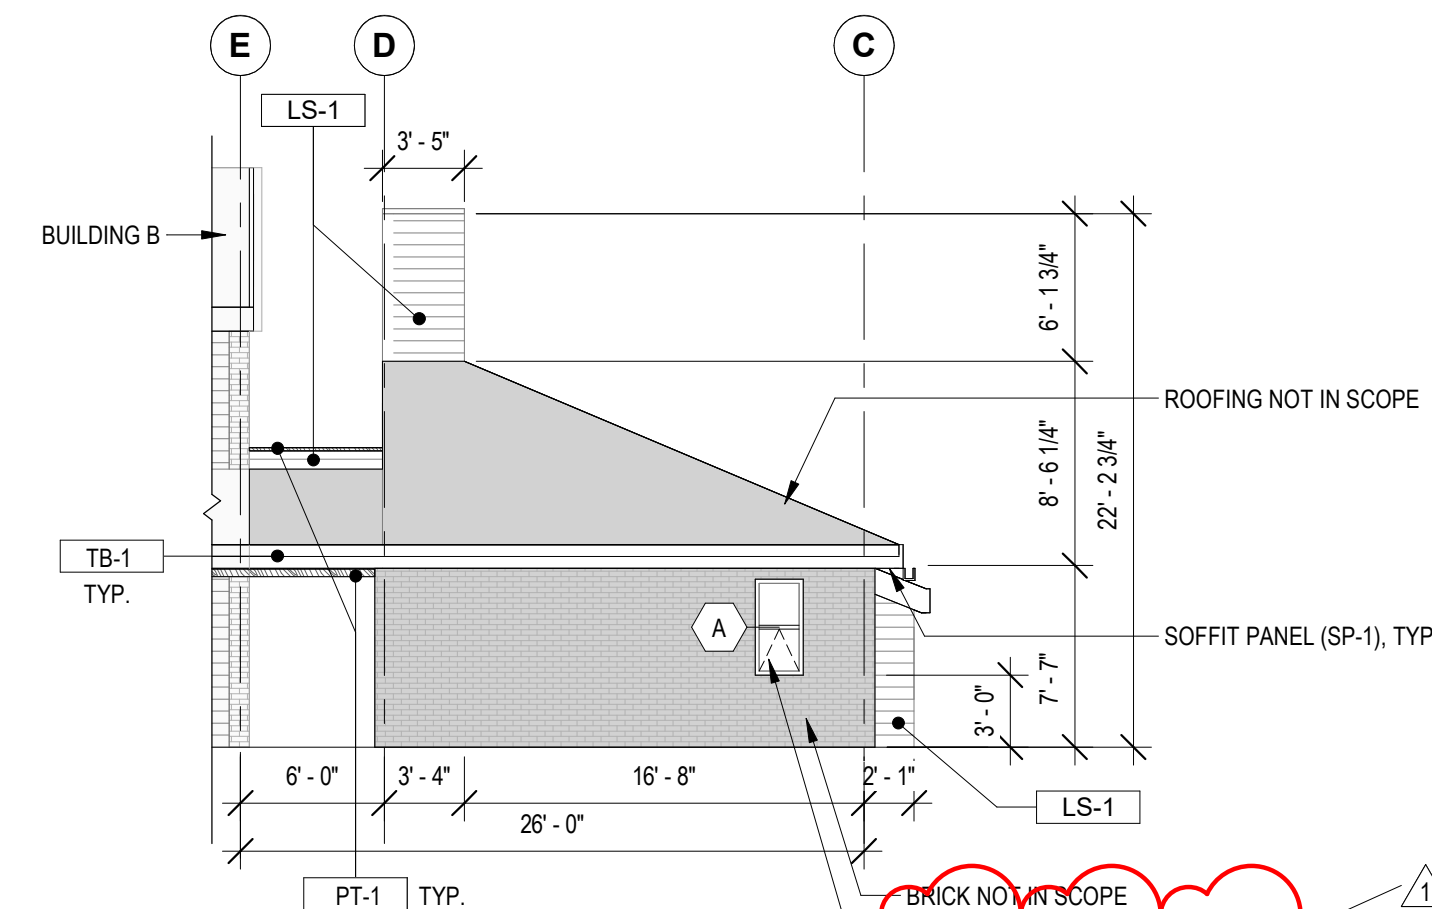


**7 BUILDING C - ELEVATION WEST (TYP)**  
1/8" = 1'-0"

NOTE: FIELD VERIFY ALL DIMENSIONS. DO NOT SCALE DRAWINGS.  
NOTE: 101 BUILDING 'C' & 102 BUILDING 'C' ARE MIRRORED VERSIONS OF TYPICAL BUILDING.


**ELEVATION NOTES**

1. ALL INFORMATION REGARDING EXISTING CONDITIONS IS BASED UPON OWNER-SUPPLIED DOCUMENTS AND MAY NOT PRECISELY REFLECT FIELD CONDITIONS.
2. THE CONTRACTOR SHALL NOT CONSIDER CONSTRUCTION NOTES TO BE ALL-INCLUSIVE. IT IS THE CONTRACTOR'S RESPONSIBILITY TO INSPECT AND ASSESS EACH AREA AND TO FULFILL THE INTENT OF THE CONTRACT DOCUMENTS. CONTRACTOR SHALL COORDINATE ARCHITECTURAL CONSTRUCTION DRAWING AND NOTES WITH CIVIL, STRUCTURAL AND MECHANICAL, ELECTRICAL & PLUMBING NOTES AND DRAWINGS.
3. FIELD VERIFY ALL DIMENSIONS. DO NOT SCALE DRAWINGS.
4. ALL FINISHES AND MATERIALS SHALL BE PROPERLY INTEGRATED TO ENSURE A UNIFORM APPEARANCE AND SEAMLESS TRANSITION.
5. ALL DIMENSIONS ARE FROM STRUCTURAL OR UNFINISHED FACE OF STUD, UNLESS OTHERWISE NOTED.
6. GENERAL CONTRACTOR SHALL COORDINATE ALL ASPECTS OF THE BUILDING CONSTRUCTION.
7. PATCH AND REPAIR ANY / ALL WALL SURFACES AS REQUIRED TO PROVIDE SUITABLE SUBSTRATE FOR FINISHES.
8. U.L. ASSEMBLIES DESCRIBED ARE FOR REFERENCE ONLY. THE GENERAL CONTRACTOR SHALL COORDINATE AND VERIFY THE INSTALLATION OF THE DESCRIBED SYSTEM(S).

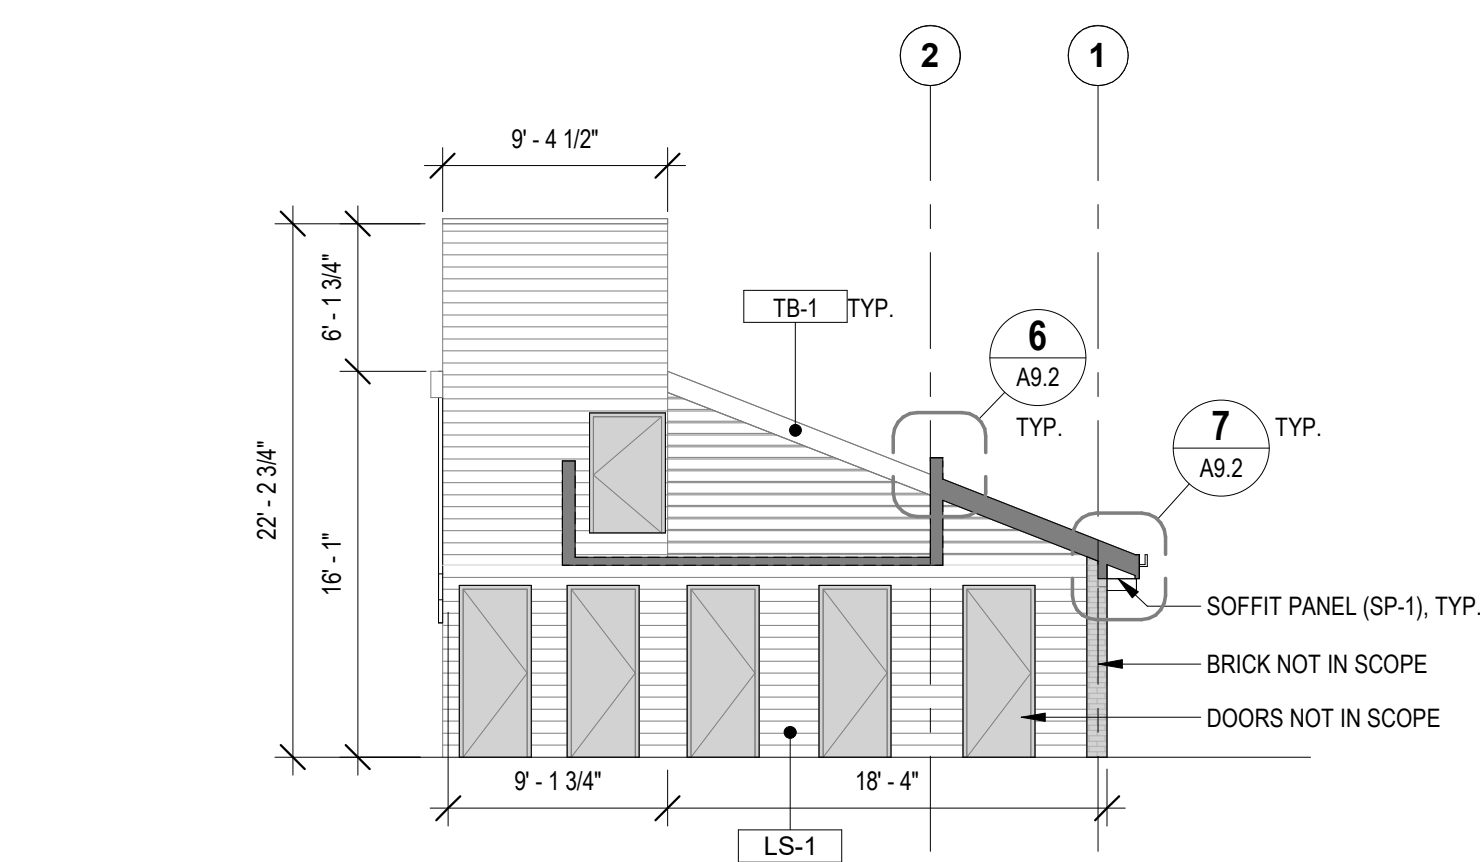


**13 BUILDING C - ELEVATION NORTH (TYP)**  
1/8" = 1'-0"

NOTE: FIELD VERIFY ALL DIMENSIONS. DO NOT SCALE DRAWINGS.  
NOTE: 101 BUILDING 'C' & 102 BUILDING 'C' ARE MIRRORED VERSIONS OF TYPICAL BUILDING.

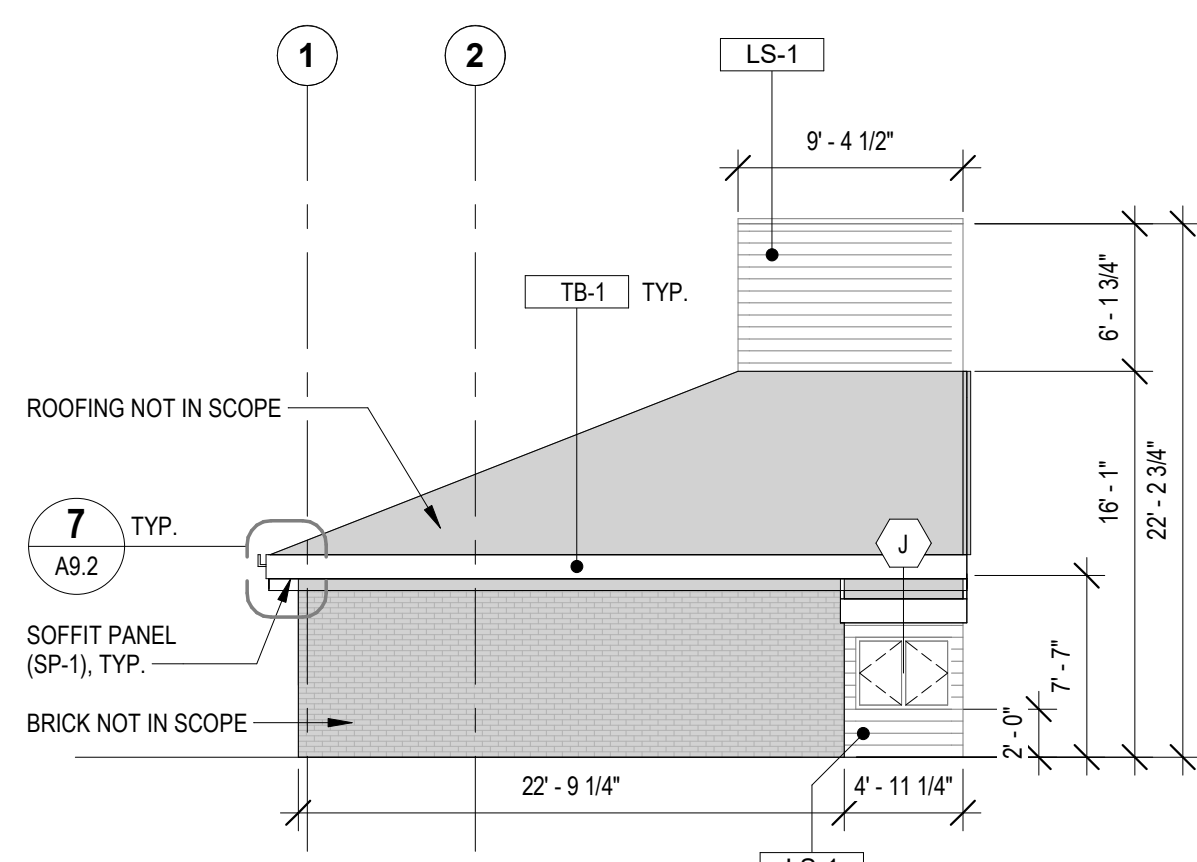

**14 BUILDING C - ELEVATION SOUTH (TYP)**  
1/8" = 1'-0"

NOTE: FIELD VERIFY ALL DIMENSIONS. DO NOT SCALE DRAWINGS.  
NOTE: 101 BUILDING 'C' & 102 BUILDING 'C' ARE MIRRORED VERSIONS OF TYPICAL BUILDING.

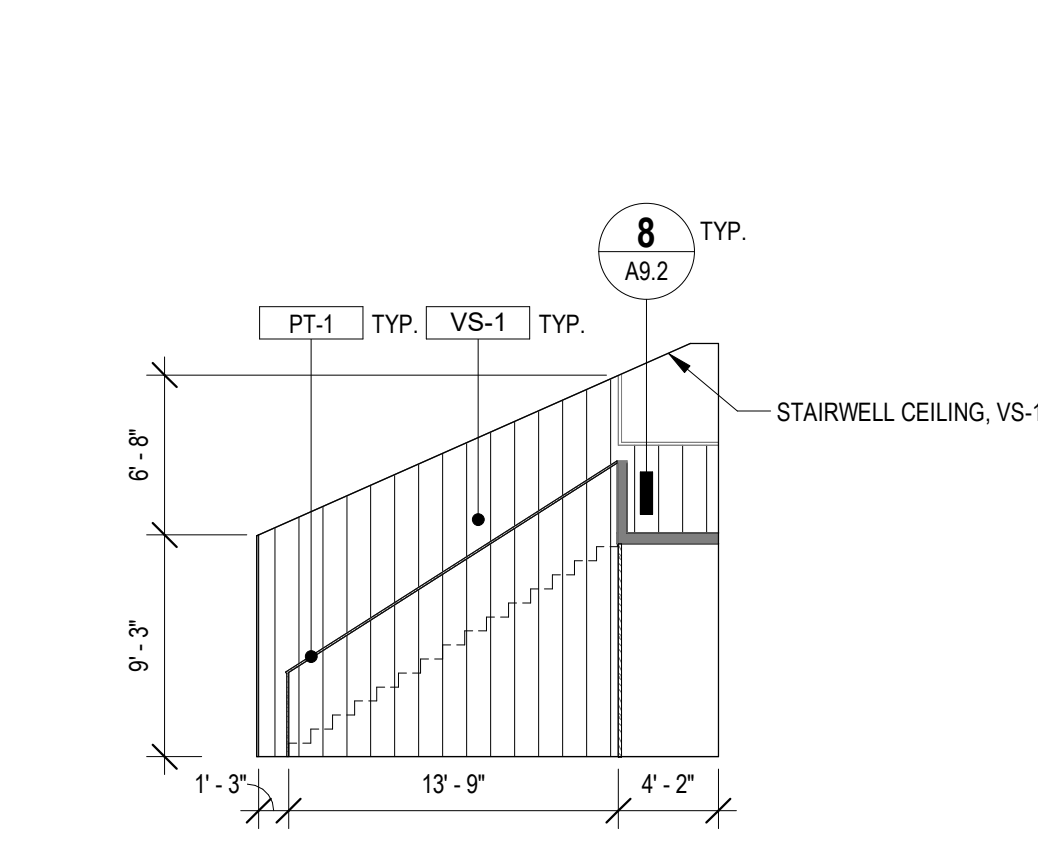

**15 BUILDING B - ELEVATION STAIRWELL INTERIOR (TYP)**  
1/8" = 1'-0"

NOTE: FIELD VERIFY ALL DIMENSIONS. DO NOT SCALE DRAWINGS.  
NOTE: 101 BUILDING 'B' & 102 BUILDING 'B' ARE MIRRORED VERSIONS OF TYPICAL BUILDING.



MSU-CPDC  
MONTANA STATE UNIVERSITY  
BOZEMAN, MONTANA  
PHONE: 406.994.5413  
FAX: 406.994.5665

MSU PAISLEY COURT HOUSING




DRAWN BY:	Author	
REVIEWED BY:	Checker	
REV.	DESCRIPTION	DATE
1	Addendum #1	12/18/24

PPA #: 21-0143  
A/E #: 21-0143  
A&E PROJ #: 23123.00


**SHEET TITLE**  
EXTERIOR ELEVATIONS  
**SHEET**  
**A4.2**

DATE  
03/29/24

BID/PERMIT SET

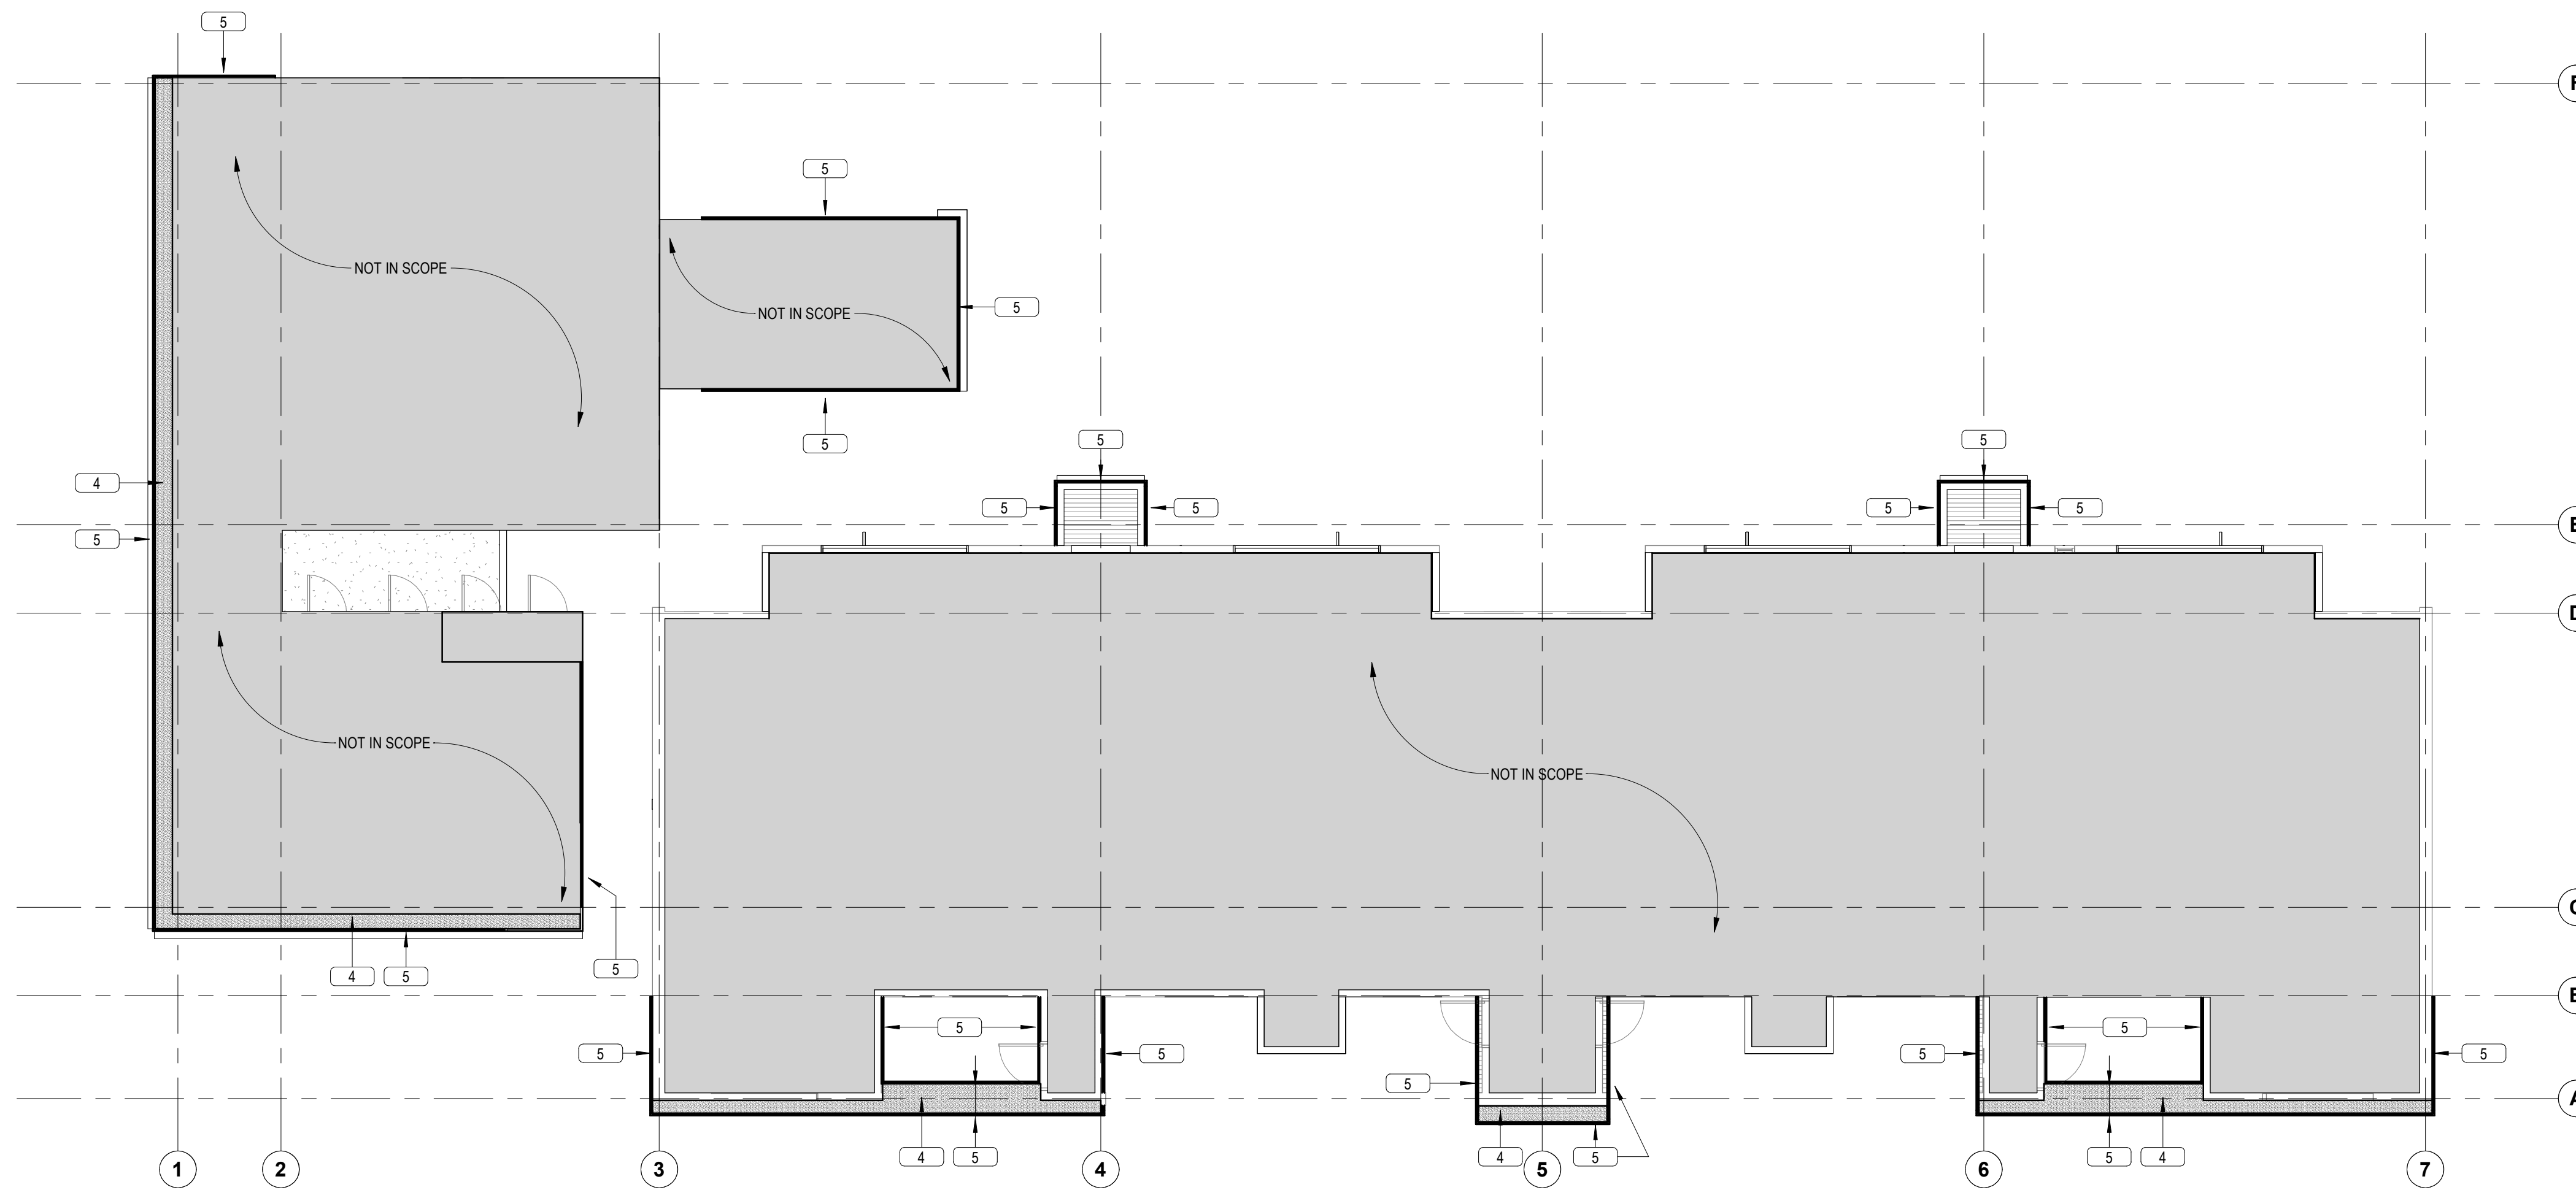



**1** LEVEL 1 REFLECTED CEILING PLAN  
1/8" = 1'-0"

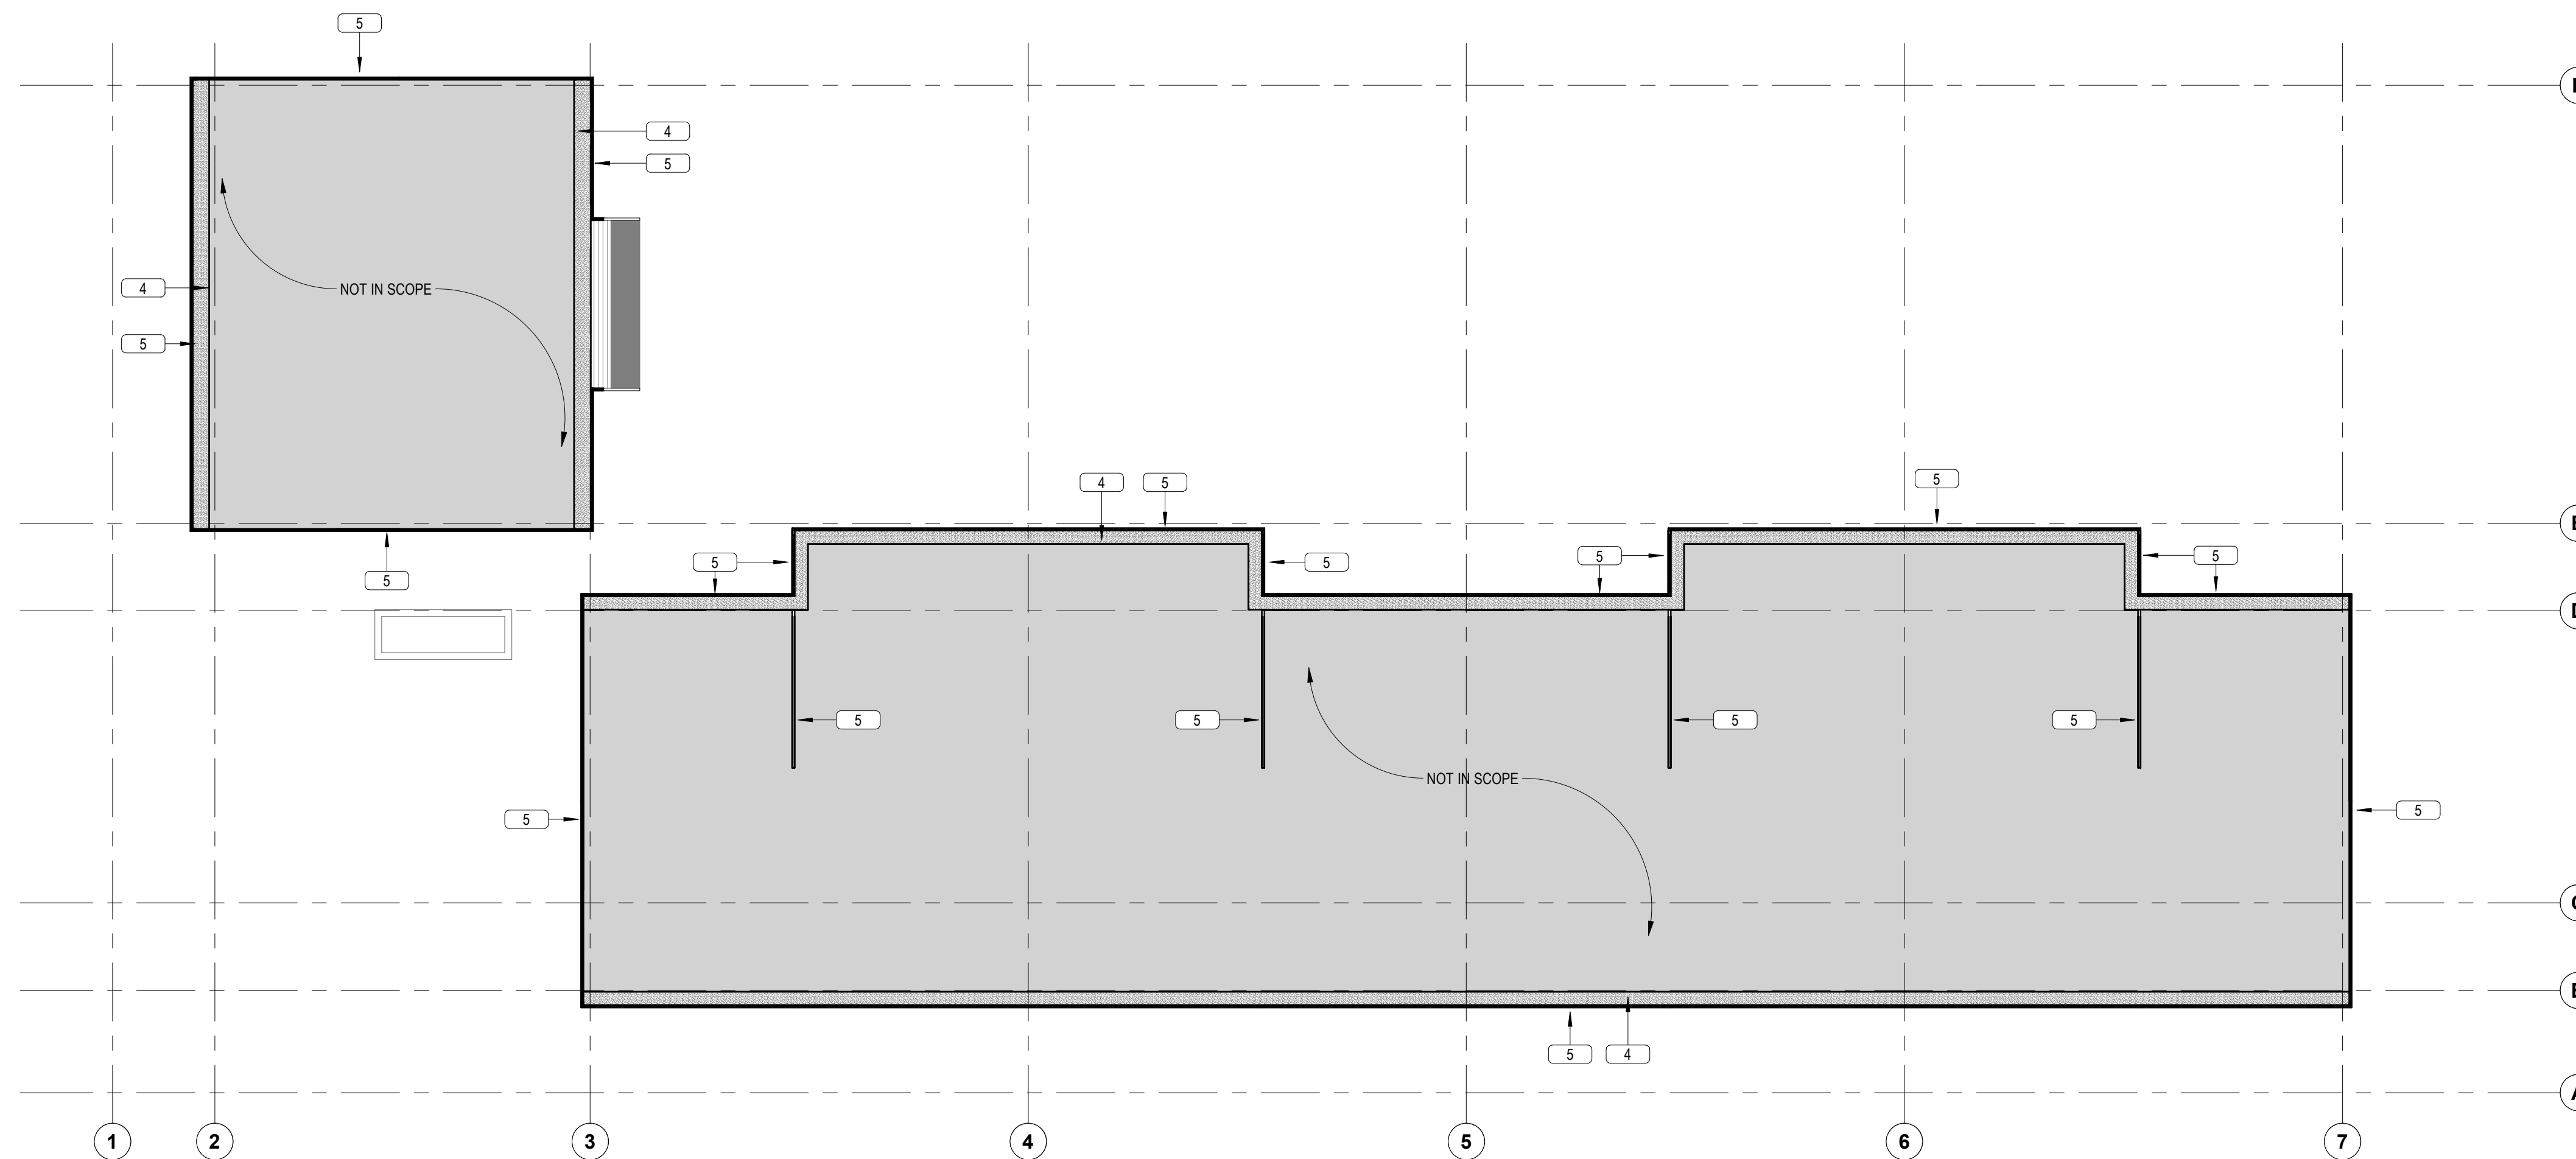

**2** LEVEL 2 REFLECTED CEILING PLAN  
1/8" = 1'-0"

**KEYNOTES**

- 4 NEW SOFFIT BOARD, TYPICAL, SEE DETAILS
- 5 NEW FASCIA BOARD AND FLASHING, TYPICAL, SEE DETAILS.

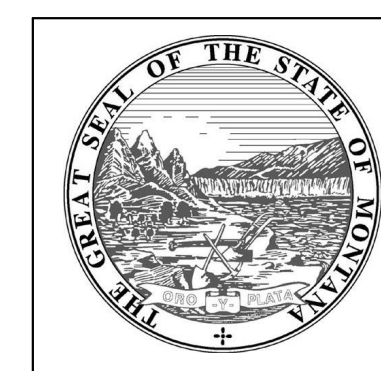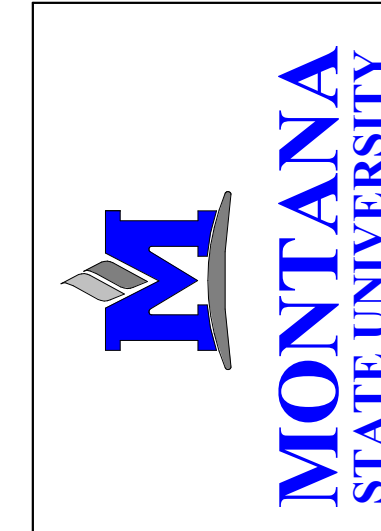

MSU-CPDC  
MONTANA STATE UNIVERSITY  
BOZEMAN, MONTANA  
PHONE: 406.994.5413  
FAX: 406.994.5665

MSU PAISLEY COURT  
HOUSING

BID/PERMIT SET



DRAWN BY: Author		
REVIEWED BY: Checker		
REV.	DESCRIPTION	DATE
1	Addendum #1	12/18/24

PPA #: 21-0143  
A/E #: 21-0143  
A&E PROJ #: 28123.00


**SHEET TITLE**  
REFLECTED  
CEILING PLANS  
**SHEET**  
**A7.1**

**DATE**  
03/29/24

WINDOW SCHEDULE					
WINDOW NUMBER	WIDTH	HEIGHT	SILL HEIGHT	HEAD HEIGHT	GLAZING TYPE
A	2'-0"	4'-0"	<varies>	<varies>	GL-1
B	2'-0"	5'-0"	<varies>	<varies>	GL-1
C	4'-0"	4'-0"	<varies>	<varies>	GL-1
D	2'-0"	2'-0"	<varies>	<varies>	GL-1
E	5'-8"	4'-0"	3'-0"	7'-0"	GL-1
F	5'-8"	5'-0"	2'-0"	7'-0"	GL-1
G	8'-0"	5'-0"	<varies>	<varies>	GL-1
H	8'-0"	4'-0"	3'-0"	7'-0"	GL-1
I	2'-0"	3'-0"	2'-0"	5'-0"	GL-1
J	4'-0"	3'-0"	2'-0"	5'-0"	GL-1



## WINDOW TYPE ELEVATIONS - VIF

NOTE: FIELD VERIFY ALL DIMENSIONS. DO NOT SCALE DRAWINGS.

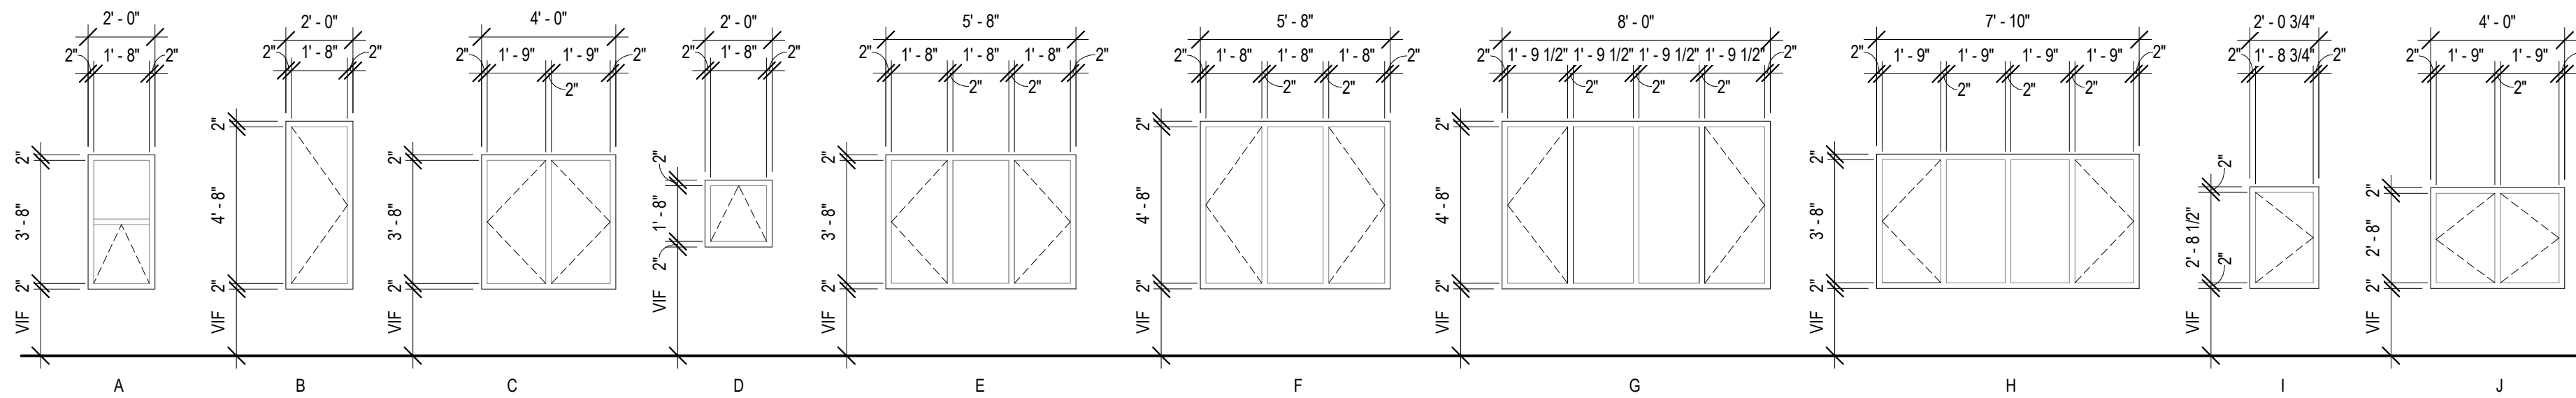

## GLAZING NOTES

1. GLAZING TO BE GL-1 UNLESS OTHERWISE SPECIFIED.
2. REFERENCE EXTERIOR ELEVATION FOR OPERABLE WINDOW OPENING DIRECTIONS.

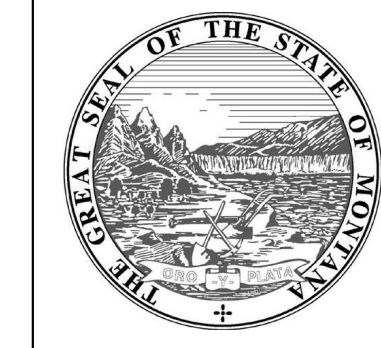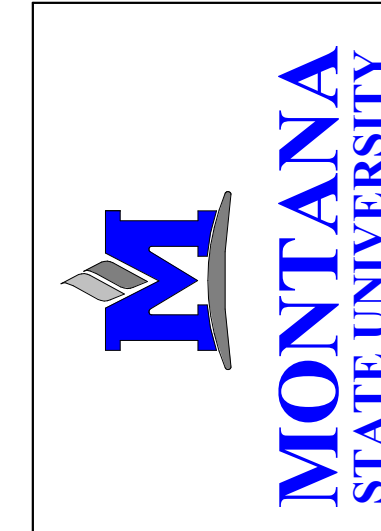

MSU-CPDC  
MONTANA STATE UNIVERSITY  
BOZEMAN, MONTANA  
PHONE: 406.994.5413  
FAX: 406.994.5665

MSU PAISLEY COURT  
HOUSING

BID/PERMIT SET



DRAWN BY: Author  
REVIEWED BY: Checker

REV.	DESCRIPTION	DATE

PPA #: 21-0143


A/E #: 21-0143

A&E PROJ #: 23123.00

SHEET TITLE  
SCHEDULES


SHEET  
**A9.1**

DATE  
03/29/24

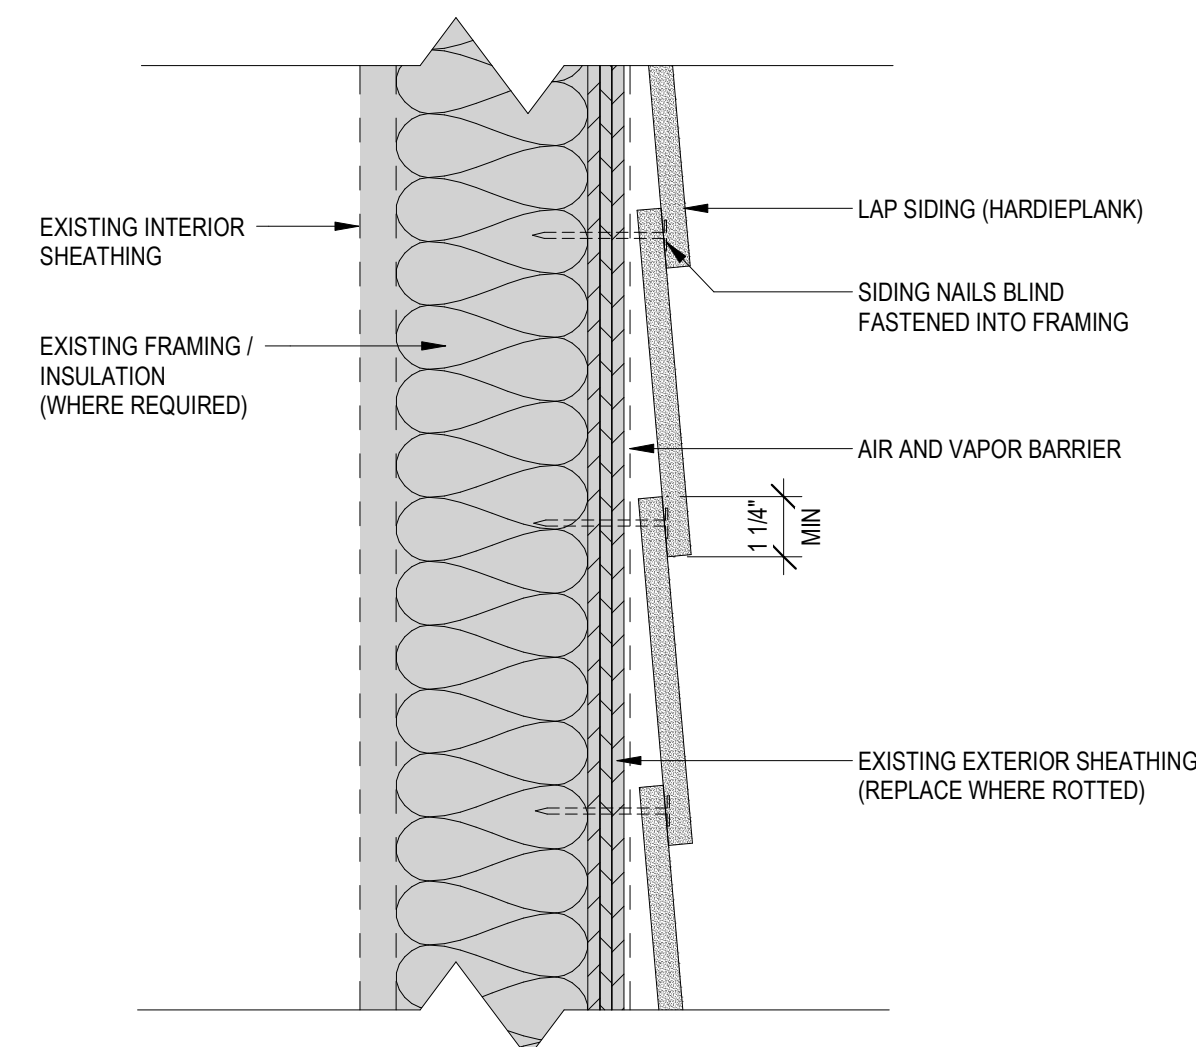


REFERENCE MANUFACTURER REQUIREMENT :  
HARDIPLANK PLANK DETAIL 1.05

**1** LAP SIDING HORIZONTAL DETAIL (TYP)  
3" = 1'-0"

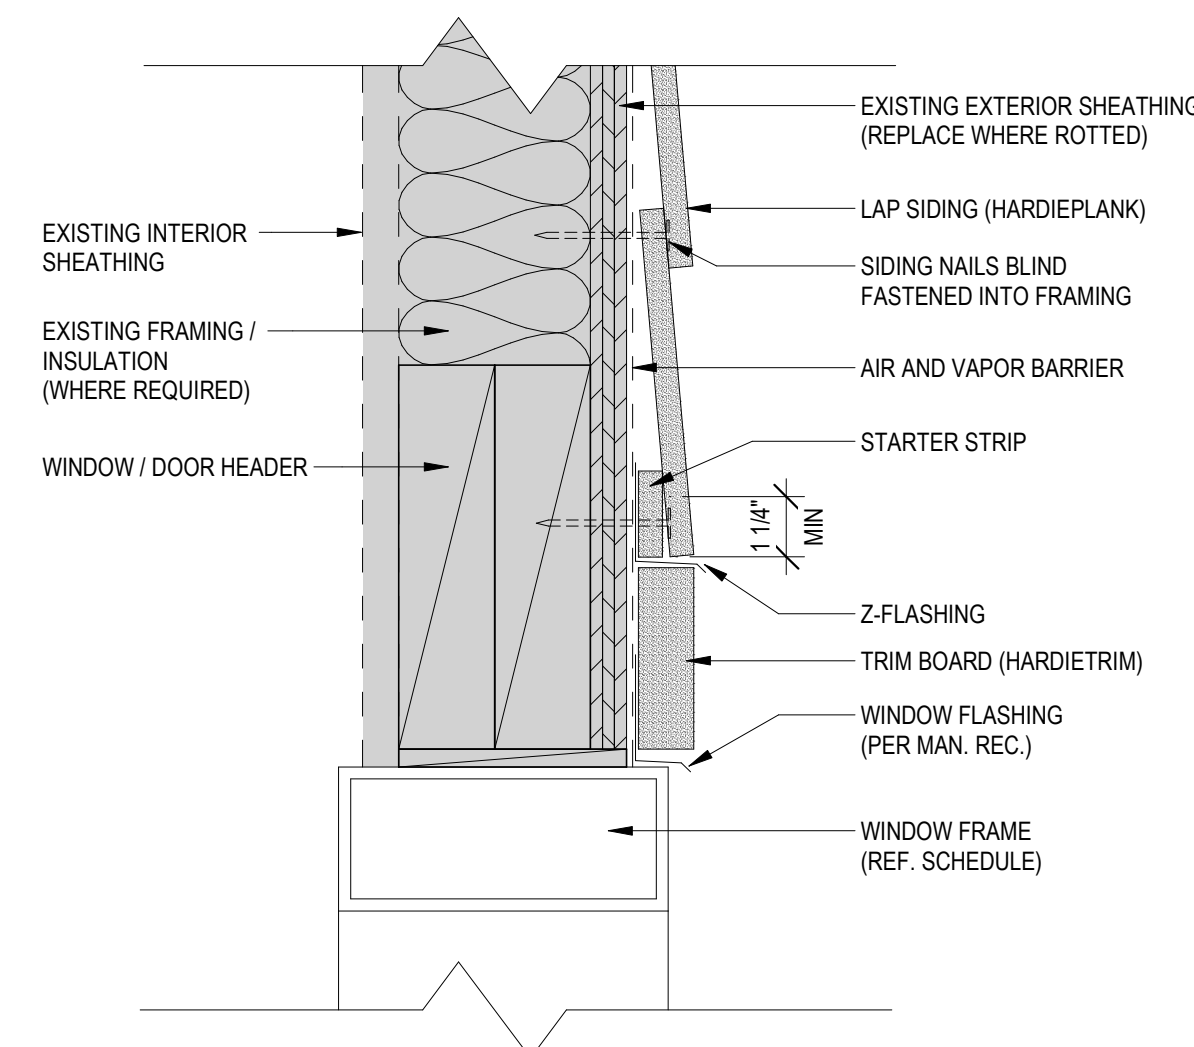


REFERENCE MANUFACTURER REQUIREMENT :  
HARDIPLANK PLANK DETAIL 1.03

**2** LAP SIDING HEADER DETAIL (TYP)  
3" = 1'-0"

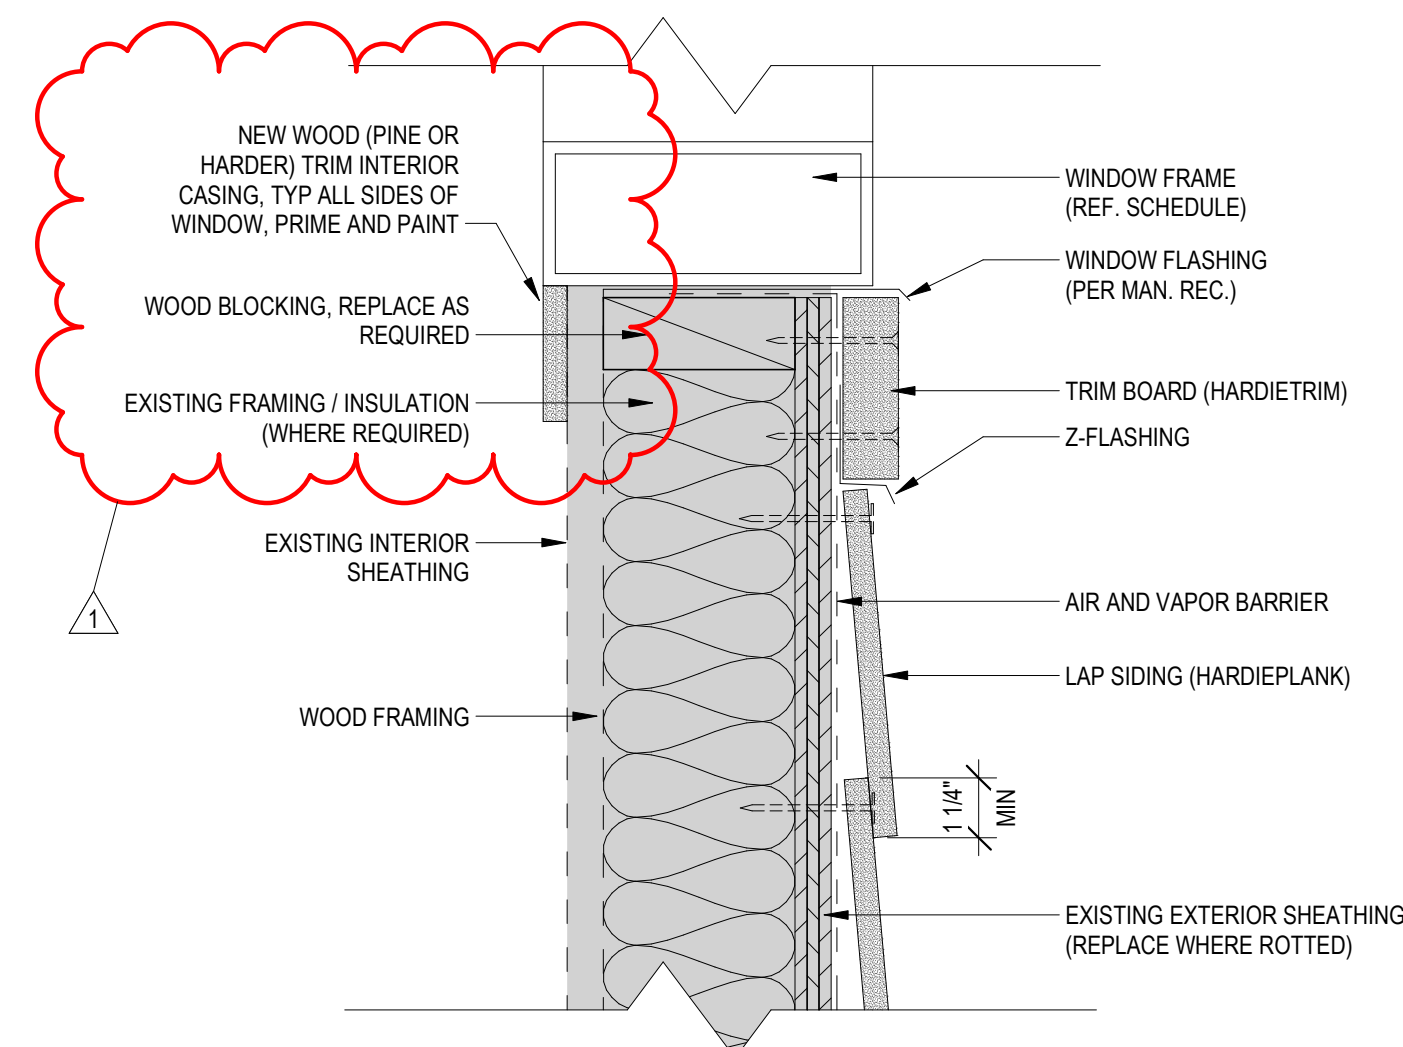


REFERENCE MANUFACTURER REQUIREMENT :  
HARDIPLANK PLANK DETAIL 1.04

**3** LAP SIDING SILL DETAIL (TYP)  
3" = 1'-0"

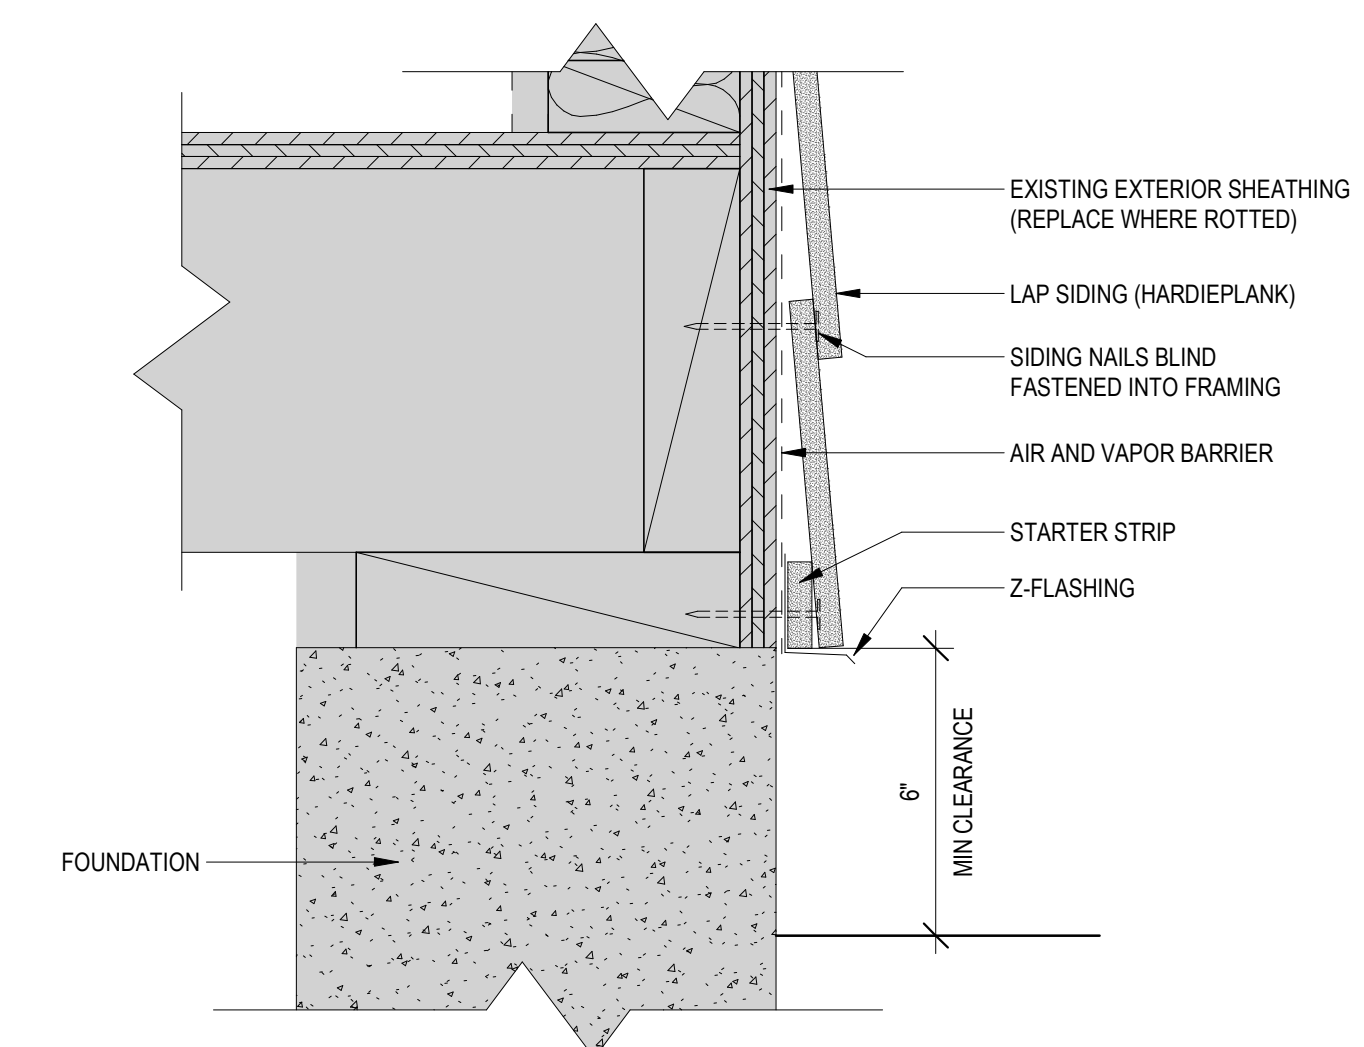


REFERENCE MANUFACTURER REQUIREMENT :  
HARDIPLANK PLANK DETAIL 1.06

**4** LAP SIDING GRADE DETAIL (TYP)  
3" = 1'-0"

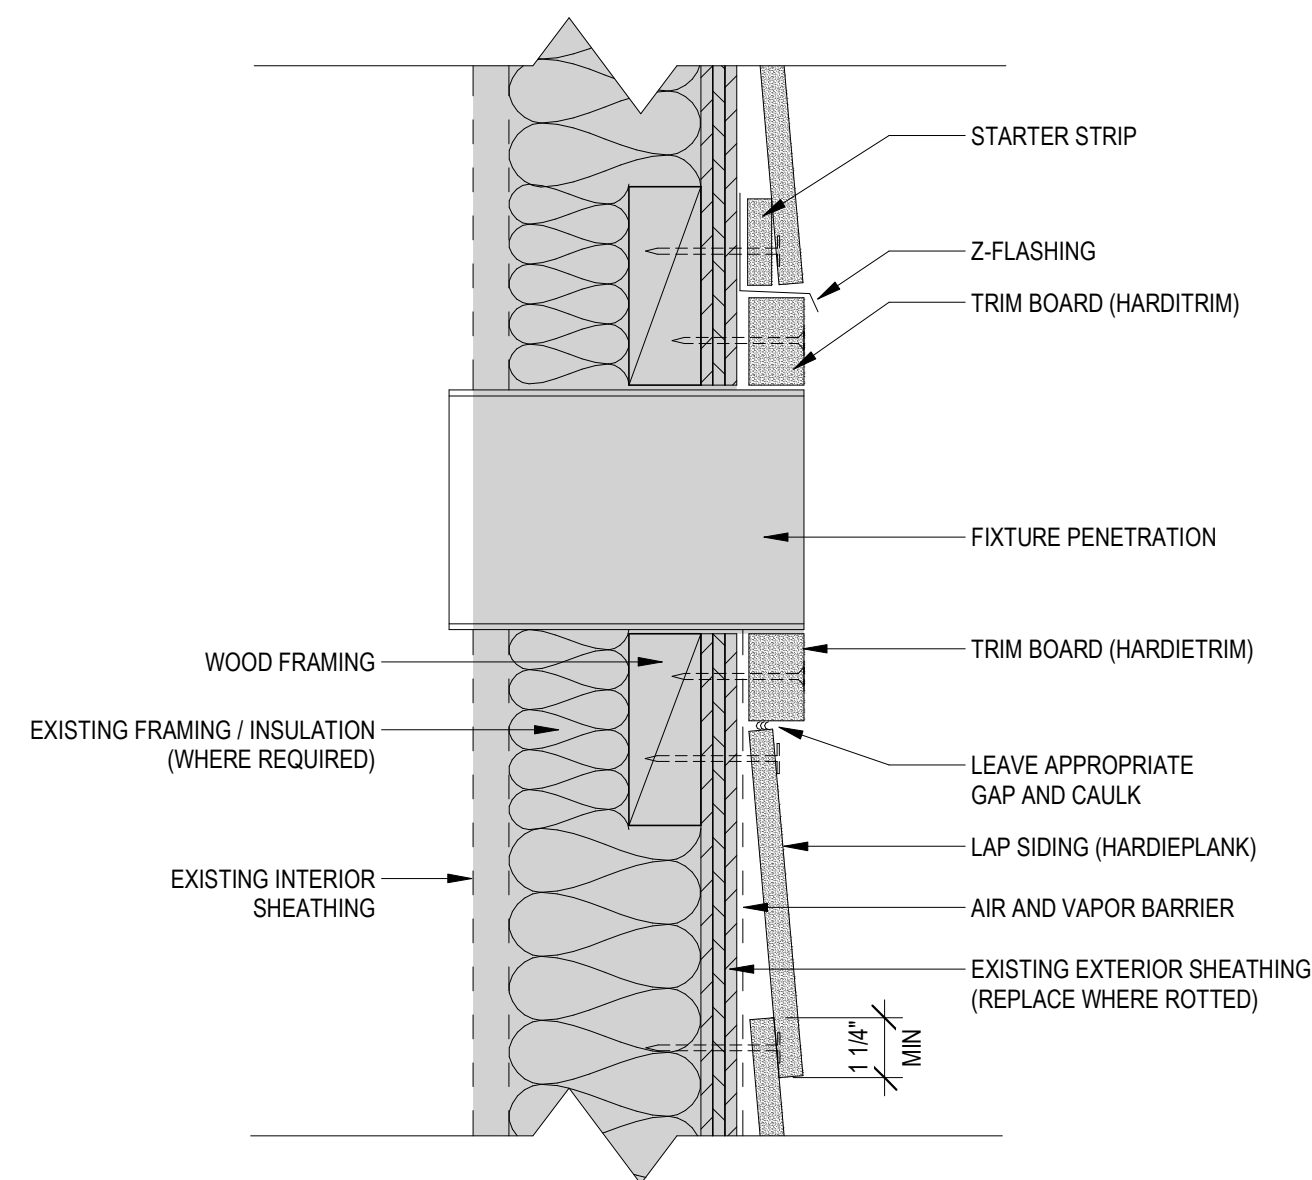


REFERENCE MANUFACTURER REQUIREMENT :  
HARDIPLANK PANEL DETAIL 1.07

**5** LAP SIDING FIXTURE PENETRATION  
3" = 1'-0"

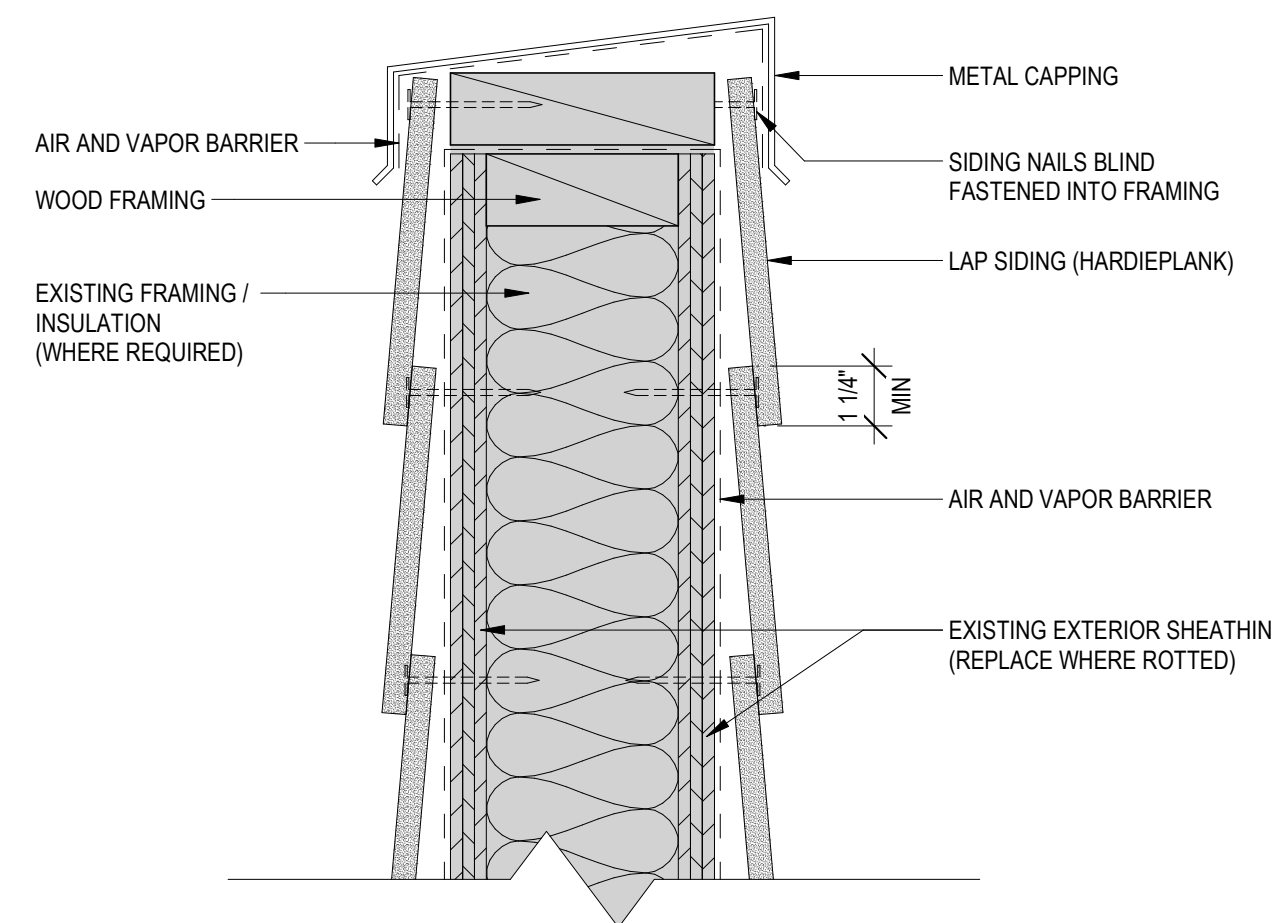


REFERENCE MANUFACTURER REQUIREMENT :  
HARDIPLANK PLANK DETAIL 1.09

**6** LAP SIDING PARAPET DETAIL  
3" = 1'-0"

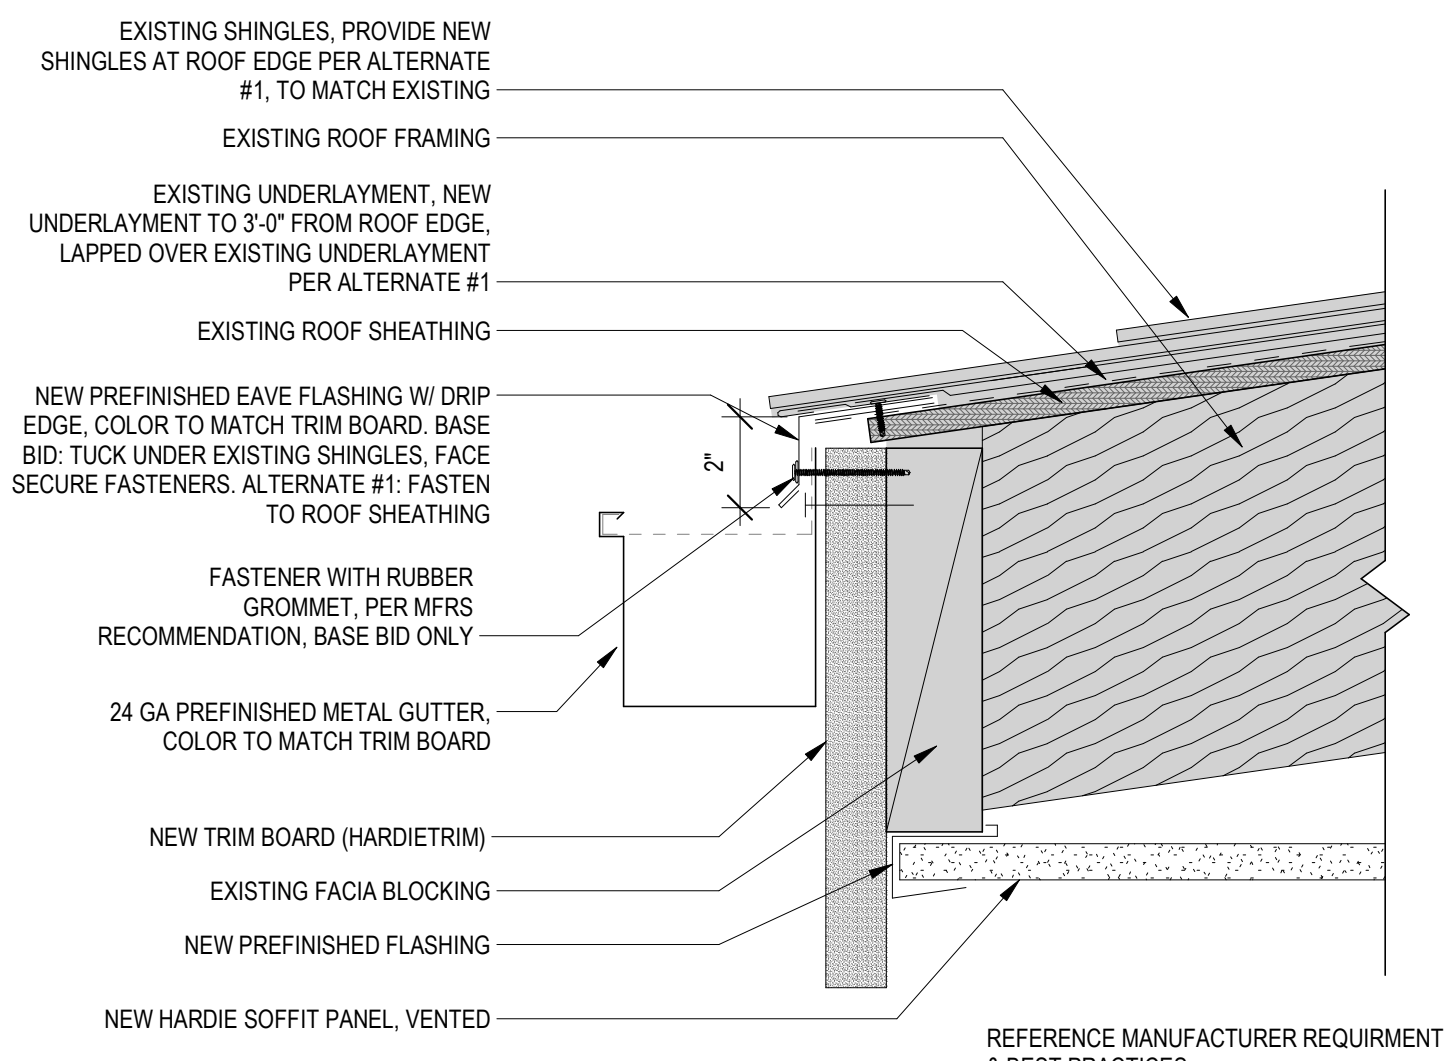


REFERENCE MANUFACTURER REQUIREMENT  
& BEST PRACTICES

**7** EAVE DETAIL (TYP)  
3" = 1'-0"

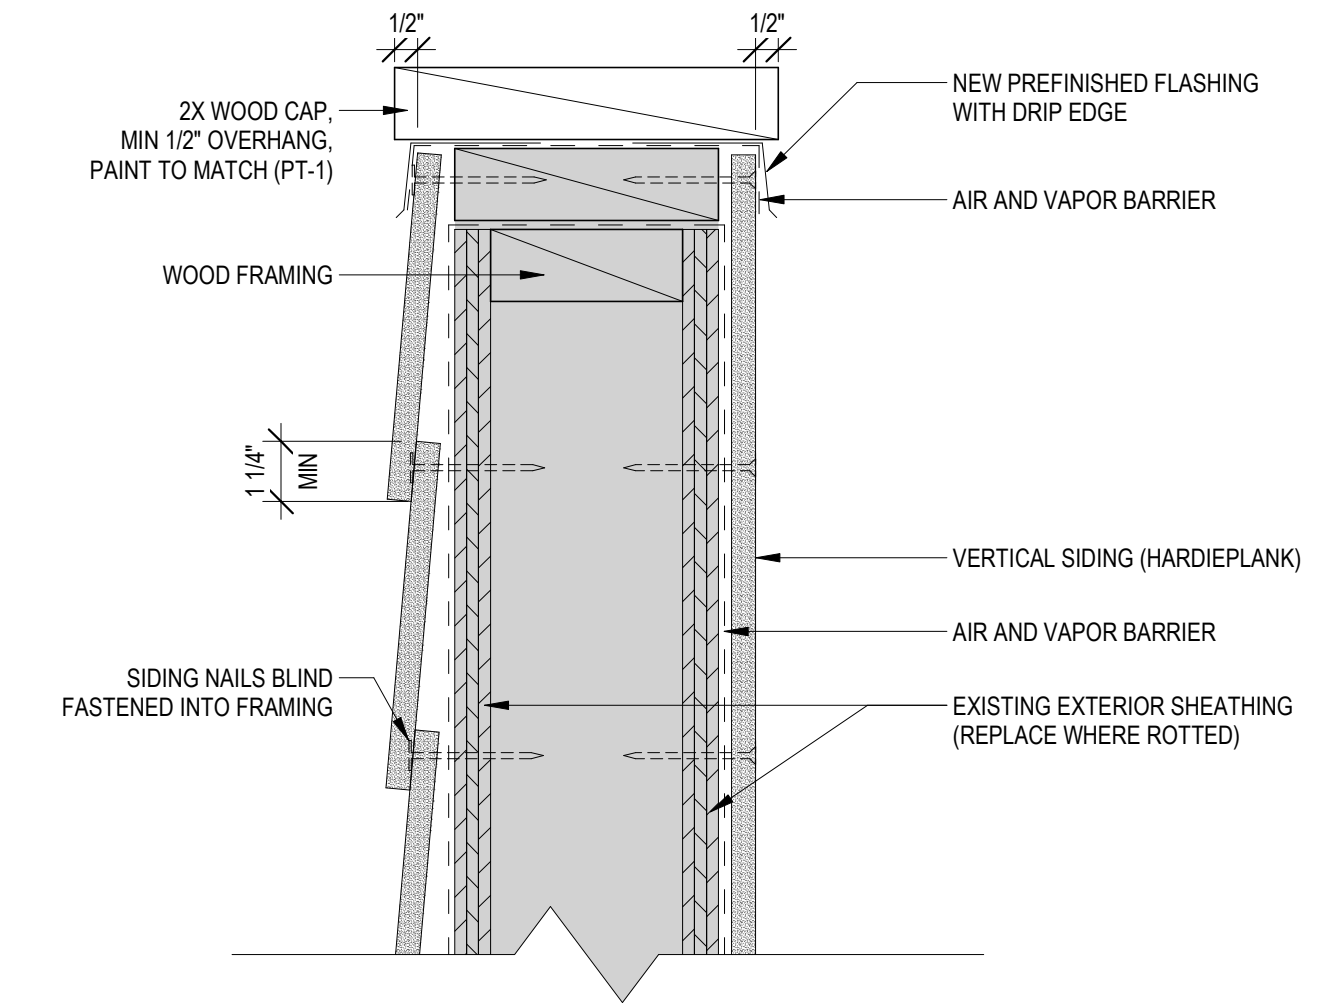


**8** LAP SIDING RAILING DETAIL (TYP)  
3" = 1'-0"

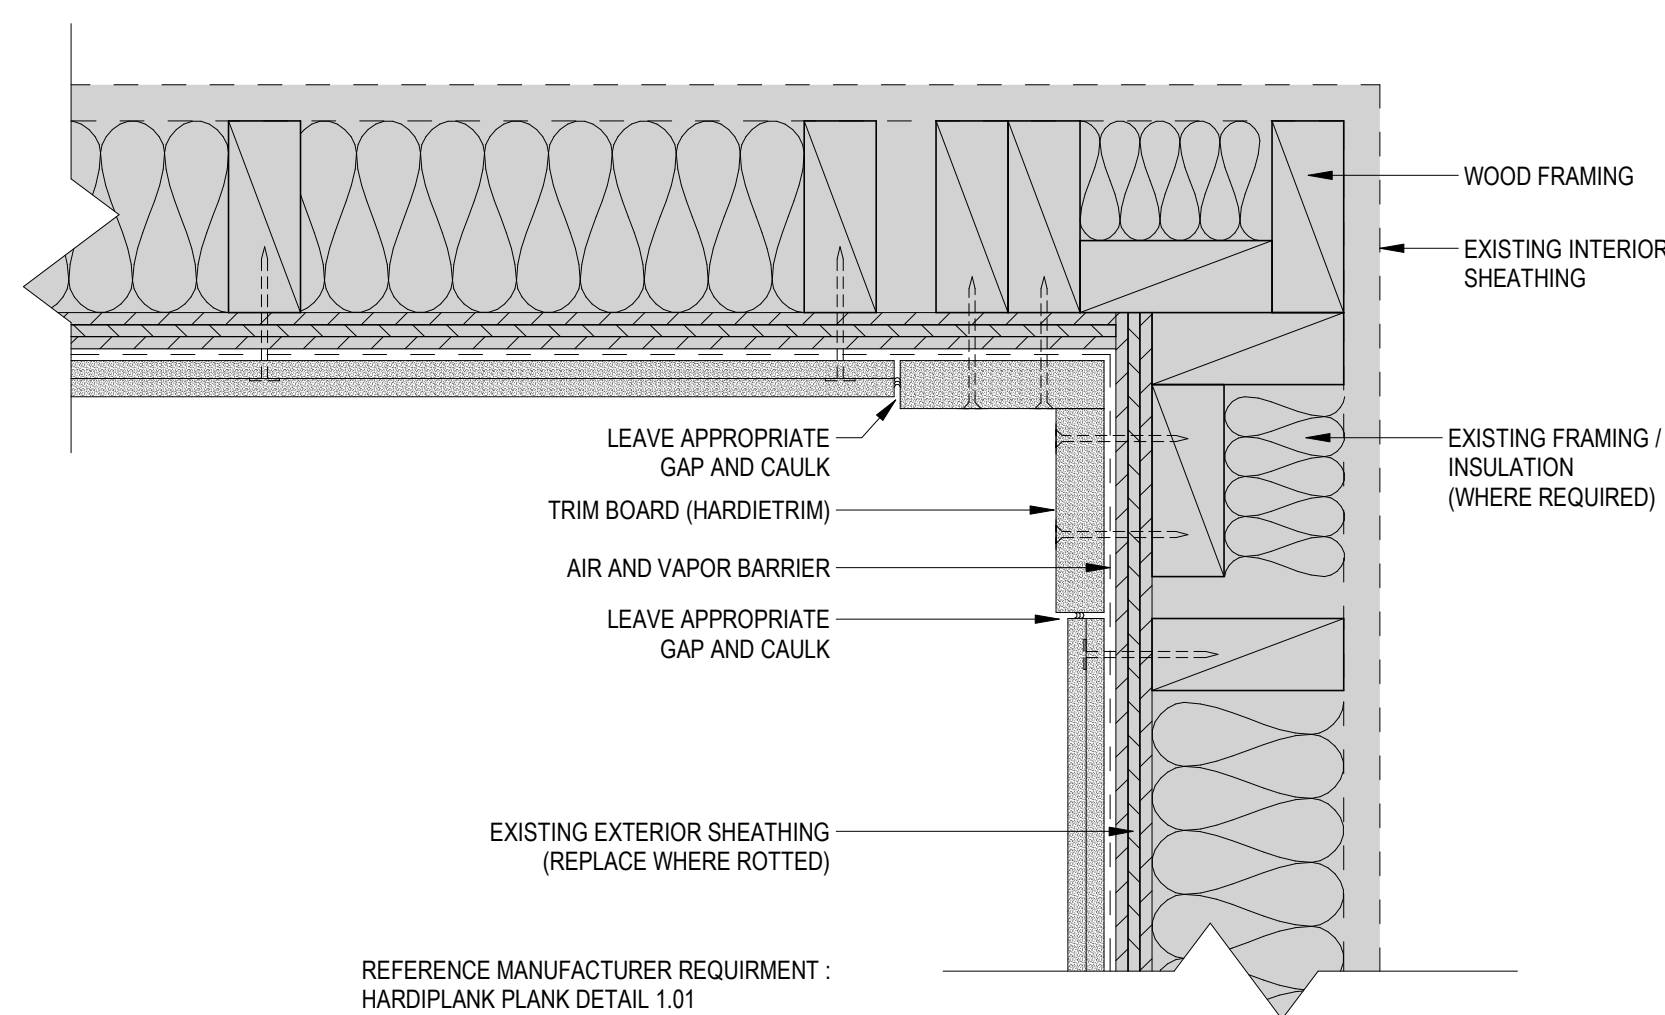


REFERENCE MANUFACTURER REQUIREMENT :  
HARDIPLANK PLANK DETAIL 1.01

**13** LAP SIDING INSIDE CORNER DETAIL (TYP)  
3" = 1'-0"

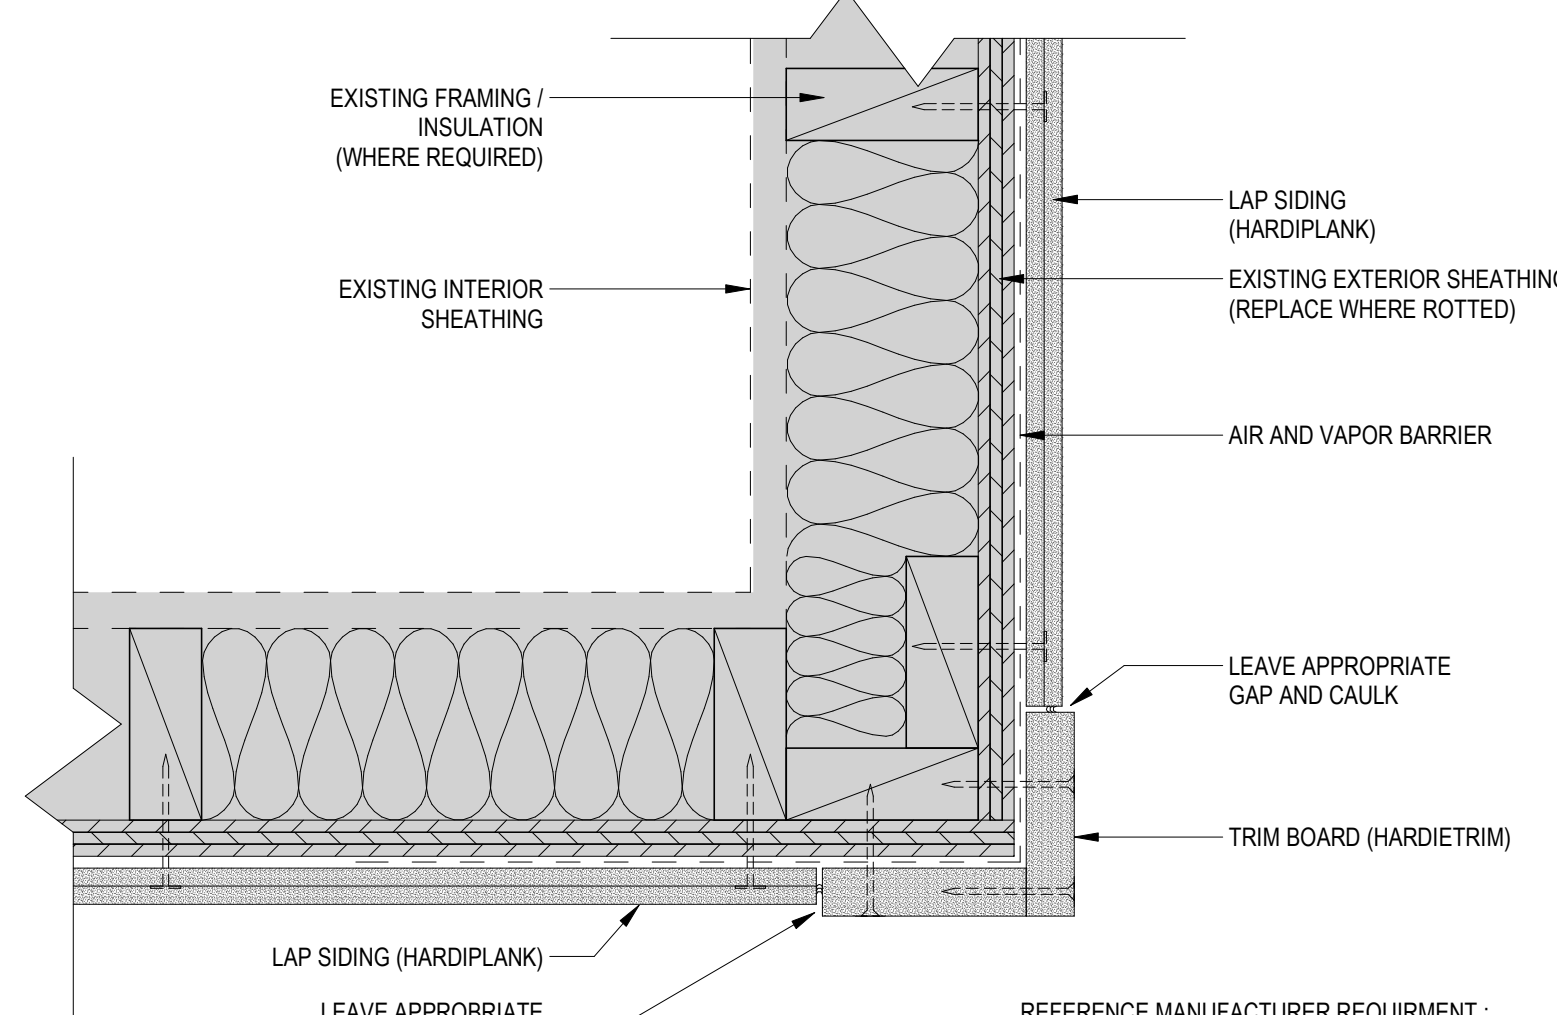

REFERENCE MANUFACTURER REQUIREMENT :  
HARDIPLANK PLANK DETAIL 1.02

**15** LAP SIDING OUTSIDE CORNER DETAIL (TYP)  
3" = 1'-0"

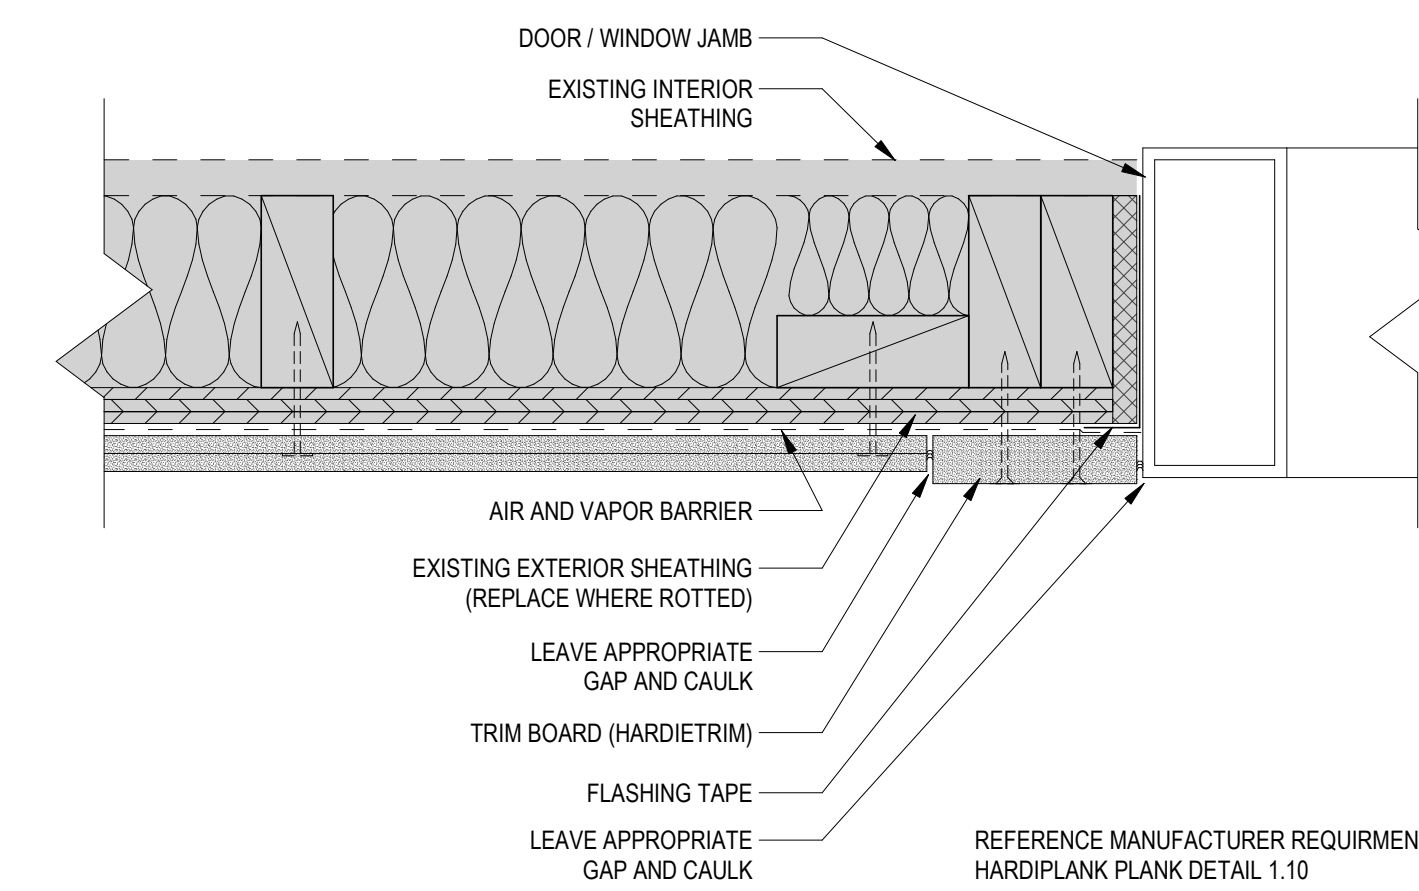

REFERENCE MANUFACTURER REQUIREMENT :  
HARDIPLANK PLANK DETAIL 1.10

**17** LAP SIDING JAMB DETAIL  
3" = 1'-0"

DRAWN BY: Author		
REVIEWED BY: Checker		
REV.	DESCRIPTION	DATE
1	Addendum #1	12/18/24

PPA #:	21-0143
A/E #:	21-0143
A&E PROJ #:	23123.00

SHEET TITLE  
DETAILS

SHEET  
**A9.2**

DATE  
03/29/24